





Public Services • Engineering Division
APPROVED STORMWATER MANAGEMENT PLAN

Date: _____ Permit # _____

Signed: _____

Approved Construction Plan
Date: 10/19/20
2020031
SWP #: 2020031
PO, ES, BM, MB, CW

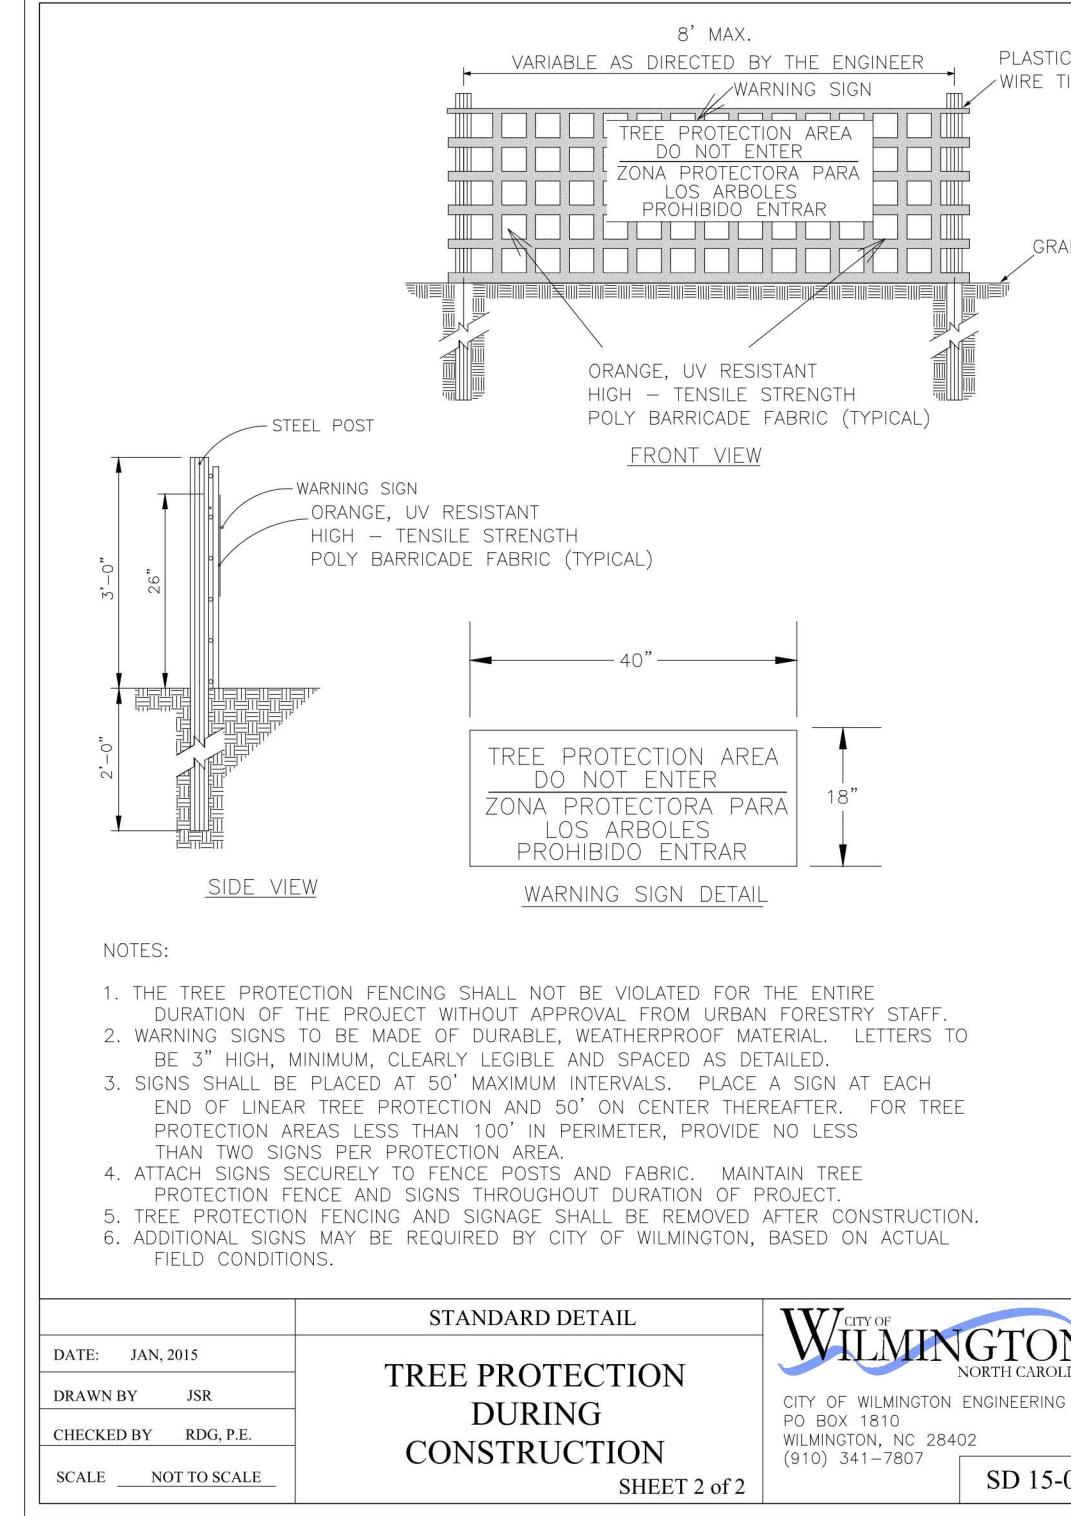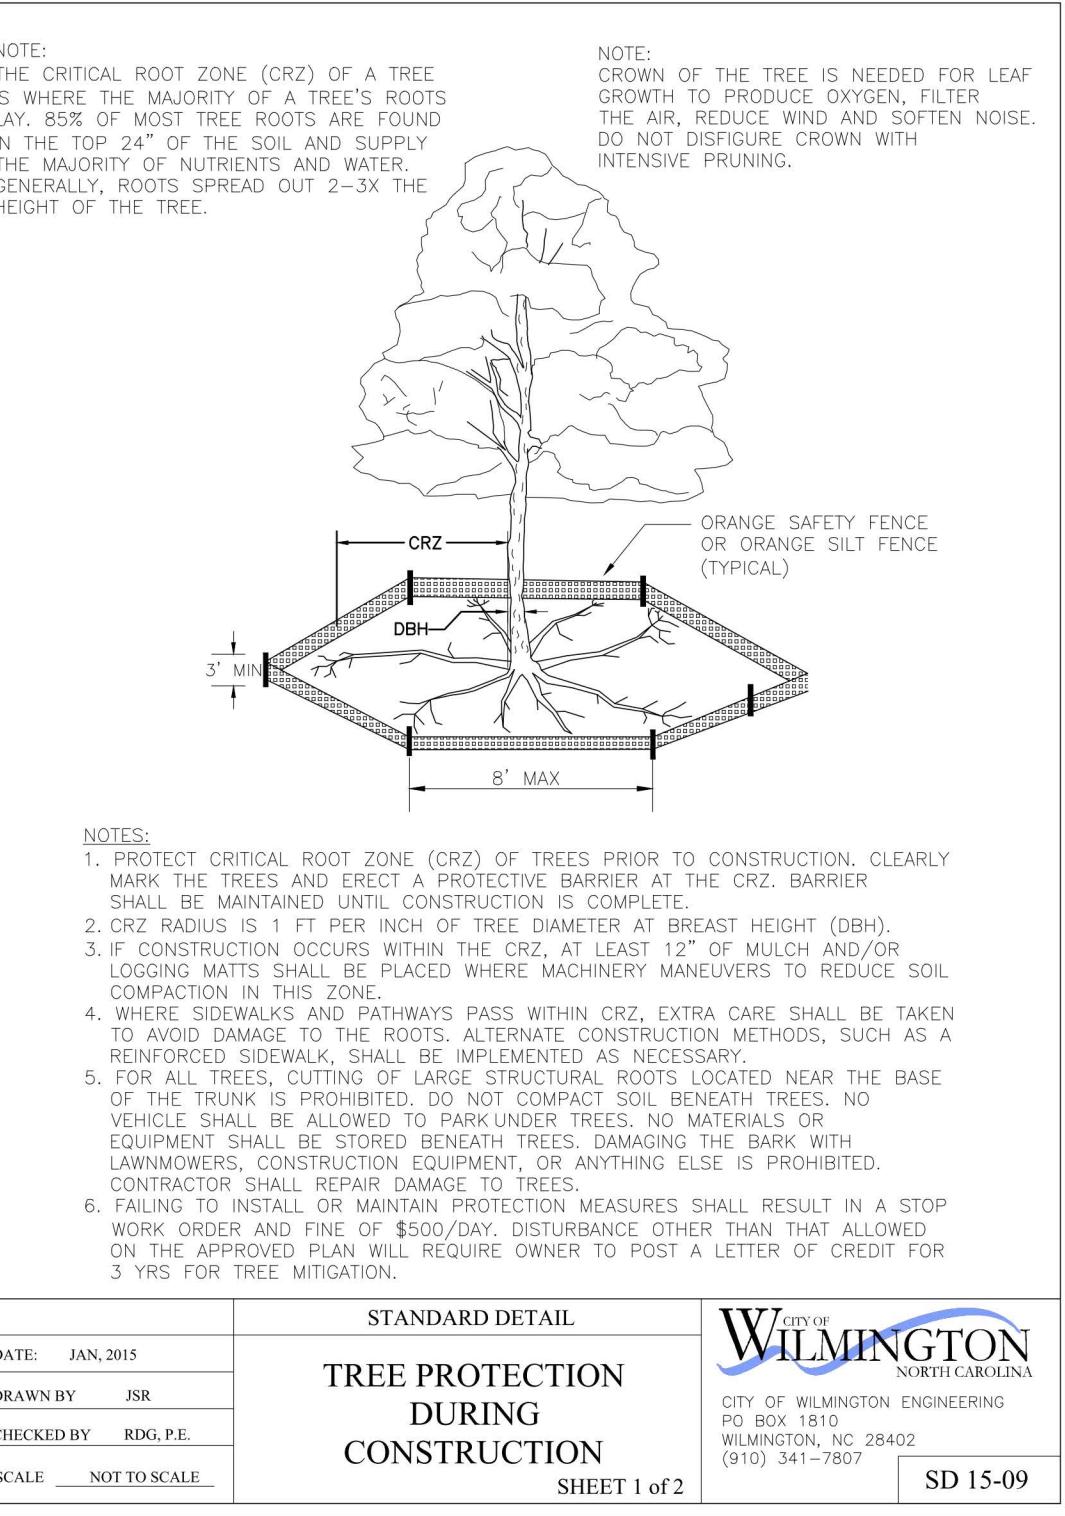

MITIGATION REQUIRED FOR REMOVAL OF SIGNIFICANT TREES

QTY	SIZE	TYPE	% MITIGATION	REPLACEMENT TREE QTY
1	32"	LOBLOLLY PINE	50%	10.67
TOTAL REPLACEMENT TREES				11

CREDITS FOR PRESERVED TREES

QTY	SIZE	TYPE	DBH	TOTAL DBH
1	15"	MAGNOLIA	15	15
1	16"	MAGNOLIA	16	16
1	19"	MAGNOLIA	19	19
17	2"	ARBORVITAE	2	34
TOTAL CREDITS FOR PRESERVED TREES				14


SITE DATA

PARCEL ID:	R05714-001-009-000, R05714-001-010-000, R05714-001-010-001
CURRENT ZONING:	CB(CD)
CAMA LAND USE CLASSIFICATION:	CONSERVATION AREA/ WATERSHED RESOURCE PROTECTION
PROJECT ADDRESS:	115, 123 & 125 CANAL ST WILMINGTON, NC 28405
CURRENT OWNER:	WILLSTHRIIL LLC PO BOX 644 WRIGHTSVILLE BEACH, NC 28480
TOTAL ACREAGE IN PROJECT BOUNDARY	55.486 SF (±1.27 ac)
EXISTING ONSITE IMPERVIOUS AREAS: (ALL IS BEING REMOVED)	
BUILDINGS	9,875 S.F.
GRAVEL	1,949 S.F.
CONCRETE	515 S.F.
TOTAL:	6,330 S.F. (11.4%)
SOIL TYPE:	Be (Baymeade fine sand) (Per the USDA websoil survey map)

- NOTES:
1. PROTECT CRITICAL ROOT ZONE (CRZ) OF TREES PRIOR TO CONSTRUCTION. CLEARLY MARK THE CRITICAL ROOT ZONE (CRZ) WITH A CRZ BARRIER.
 2. CRZ RADIUS IS 1 FT. PENT INCH OF TREE DIAMETER AT BREAST HEIGHT (DBH).
 3. LOGGING MATS SHALL BE PLACED WHERE MACHINERY MANEUVERS TO REDUCE SOIL COMPACTION IN THIS ZONE.
 4. WHERE WALKS OR PATHWAYS PASS WITHIN CRZ, EXTRA CARE SHALL BE TAKEN TO AVOID DAMAGE TO THE ROOTS. ALTERNATE CONSTRUCTION METHODS, SUCH AS A REINFORCED SIDEWALK, SHALL BE IMPLEMENTED AS NECESSARY.
 5. FOR ALL TREES, CUTTING OF LARGE STRUCTURAL ROOTS LOCATED NEAR THE BASE OF THE TREE SHALL BE PROHIBITED. NO EQUIPMENT SHALL BE STORED BEHIND TREES. NO VEHICLE SHALL BE ALLOWED TO PARK UNDER TREES. NO MATERIALS OR EQUIPMENT SHALL BE STORED BEHIND TREES. DAMAGING THE BARK WITH LAMINATING COMPRESSORS IS PROHIBITED.
 6. FAILING TO INSTALL OR MAINTAIN PROTECTION MEASURES SHALL RESULT IN A STOP WORK ORDER. DEDUCTIVE FEE \$500/DAY. DISTURBANCE OTHER THAN THAT ALLOWED ON THE APPROVED PLAN WILL REQUIRE OWNER TO POST A LETTER OF CREDIT FOR 3 YRS FOR TREE MITIGATION.

STANDARD DETAIL		WILMINGTON
DATE: JAN. 2015	DRAWN BY: JSR	CITY OF WILMINGTON ENGINEERING PO BOX 1810 WILMINGTON, NC 28402 (910) 341-7807
CHECKED BY: RDG, P.E.		
SCALE: NOT TO SCALE		SD 15-09
TREE PROTECTION DURING CONSTRUCTION		SHEET 1 of 2


STANDARD DETAIL		WILMINGTON
DATE: JAN. 2015	DRAWN BY: JSR	CITY OF WILMINGTON ENGINEERING PO Box 1810 WILMINGTON, NC 28402 (910) 341-7807
CHECKED BY: RDG, P.E.		
SCALE: NOT TO SCALE		SD 15-09
TREE PROTECTION DURING CONSTRUCTION		SHEET 2 of 2

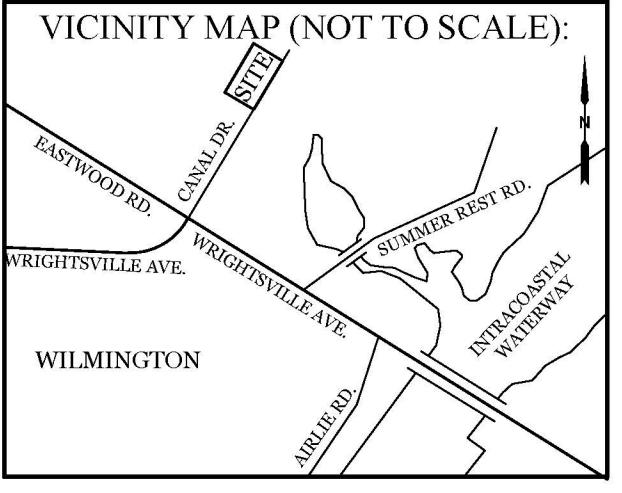


REVISIONS

**INTRACOASTAL
ENGINEERING, PLLC**
5725 Oleander Dr. Unit E-7
Wilmington, North Carolina 28403
Phone: 910.859.8983
Email: Charlie@intracoastalengineering.com

License Number: P-0662

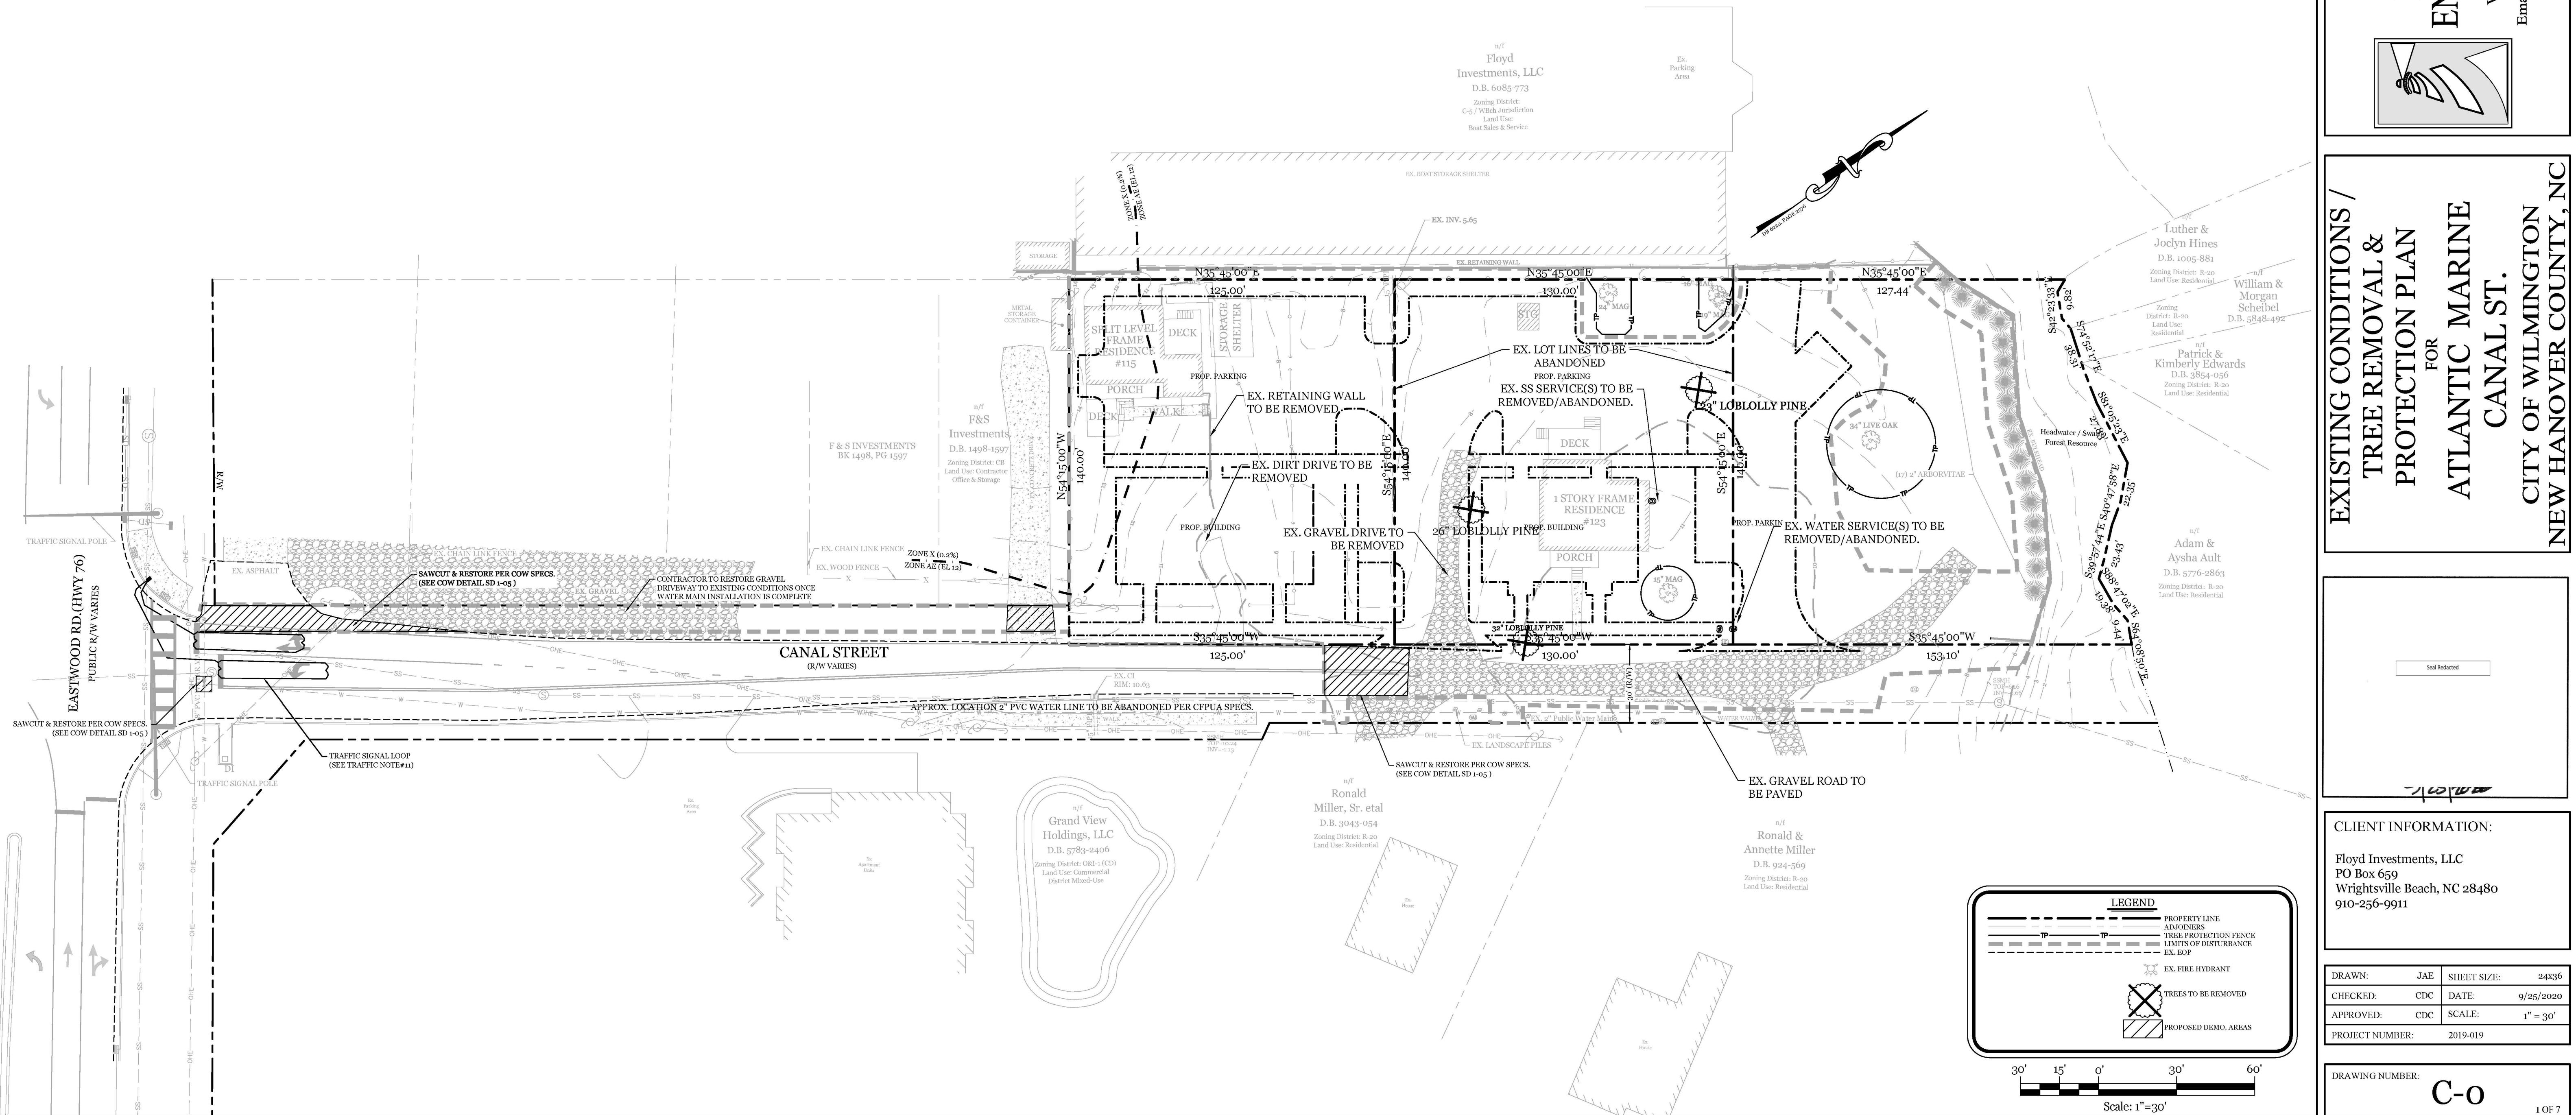

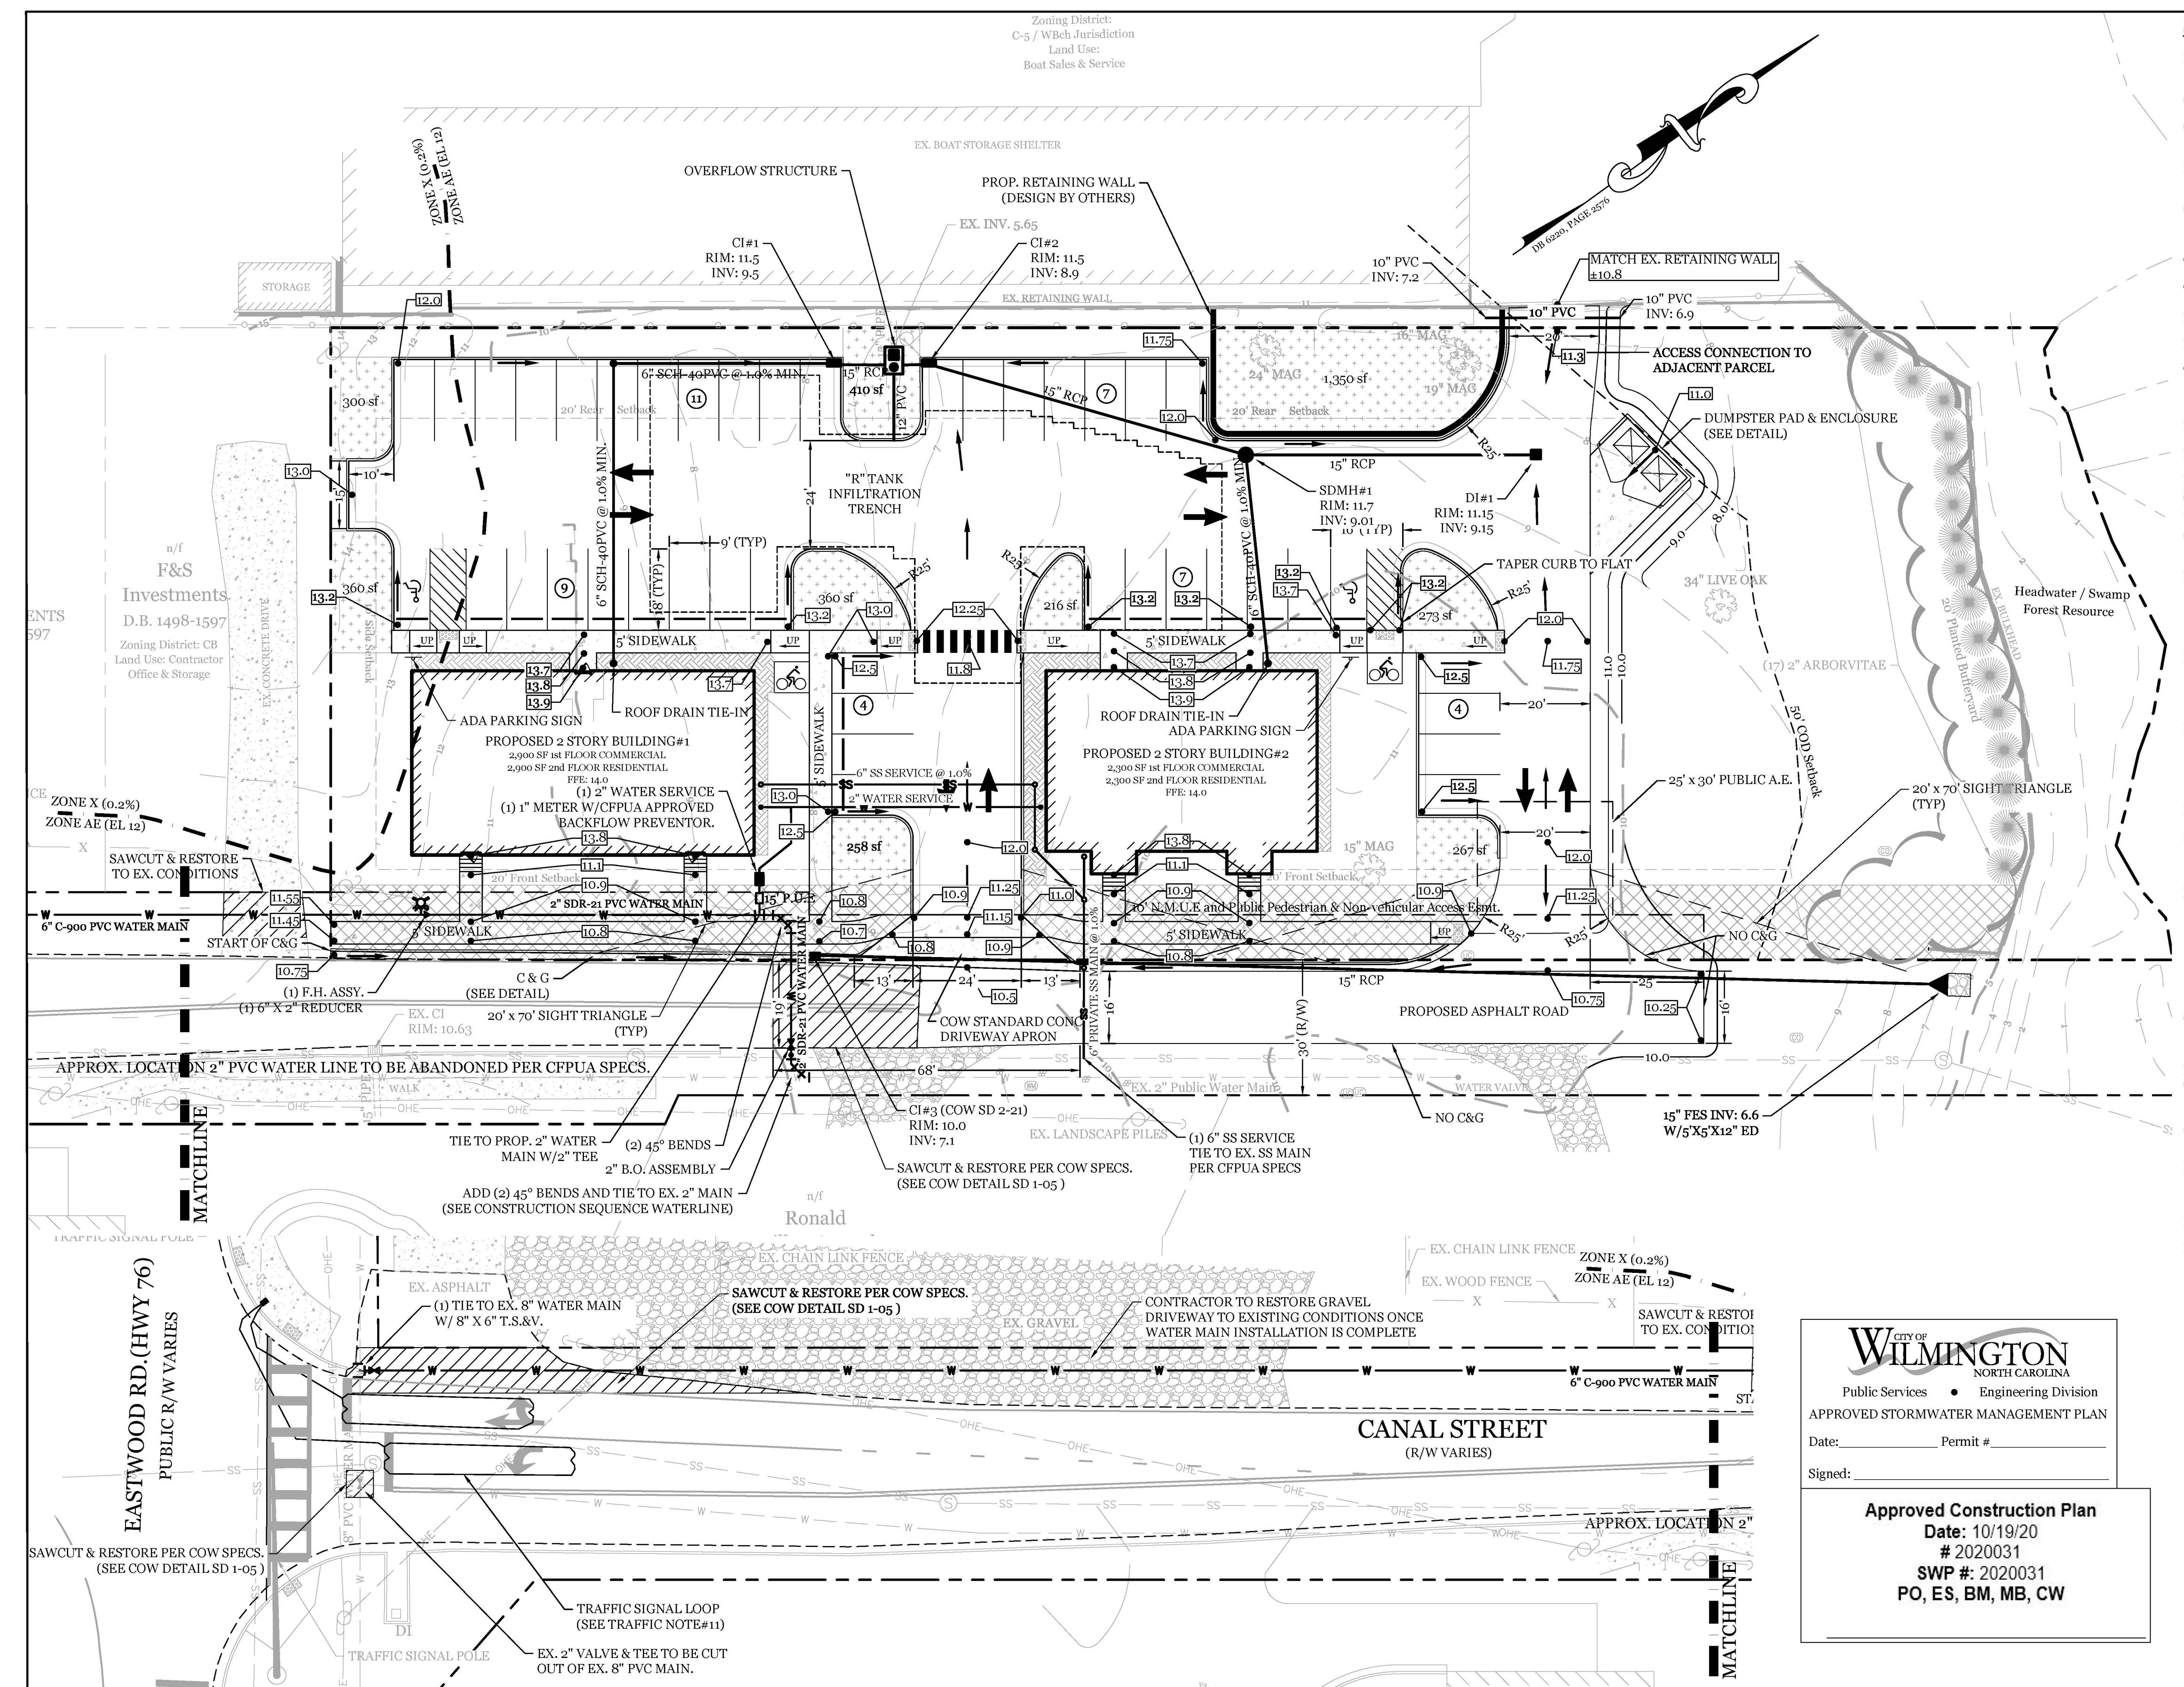
SITE DATA

PARCEL ID: R05714-001-009-000, R05714-001-010-000,
R05714-001-010-001

CURRENT ZONING: CB(CD)

CAMA LAND USE CLASSIFICATION: CONSERVATION AREA/
WATERSHED RESOURCE PROTECTION

PROJECT ADDRESS: 115, 123 & 125 CANAL ST
WILMINGTON, NC 28405

CURRENT OWNER: WILLSTHILL LLC
PO BOX 644
WRIGHTSVILLE BEACH, NC 28480

TOTAL ACREAGE IN PROJECT BOUNDARY: 55.48 SF (± 1.27 ac.)

TOTAL DISTURBED AREA: ± 1.25 ACRES

NUMBER OF BUILDINGS: 2

PROPOSED USE: MIXED USE

TOTAL BUILDING SIZE IN GFA: BUILDING#1 5,800 S.F. GFA
BUILDING#2 4,600 S.F. GFA
TOTAL: 10,400 S.F. GFA

BUILDING HEIGHT: $\pm 25'$ / 2 STORY (35' MAX. ALLOWED)

BUILDING SETBACKS:

FRONT: REQUIRED = 20'
SIDE: REQUIRED = 21'L/98'R
REAR: REQUIRED = 20'

PROPOSED COVERAGE: PROPOSED = 24'
CALCULATION FOR BUILDING COVERAGE: PROPOSED COVERAGE = 5,500 S.F. ÷ 55,486 S.F. = 1.0%

PROPOSED ON-SITE IMPERVIOUS AREAS: BUILDING ROOF 5,500 S.F.
CONCRETE SIDEWALK, C&G, ETC. 3,600 S.F.
ASPHALT DRIVES 16,985 S.F.
TOTAL: 26,085 S.F. (47.0%)

PROPOSED OFF-SITE IMPERVIOUS AREAS: ASPHALT ROAD 3,313 S.F.
CONCRETE DRIVE APRONS/SIDEWALK 1,530 S.F.
TOTAL: 4,843 S.F.

PARKING REQUIRED (5,200 S.F. PROFESSIONAL OFFICE & (2) TWO BEDROOM APARTMENTS):

MIN: 2.0 Spaces/du + 1/300 sq.ft. Commercial = 29 SPACES

MAX: 2.5 Spaces/du + 1/200 sq.ft. Commercial = 41 SPACES

PARKING PROVIDED: 42 SPACES (2 H.C.)

BICYCLE PARKING REQUIRED: (MIN. 5 PER 25-125 VEHICLE SPACES)
REQUIRED: 5 SPACES
PROVIDED: 10 SPACES

FOUNDATION PLANTINGS: BUILDING #1: 112.5 LF X 25' FAÇADE X 12%
REQUIRED: 338 S.F.
PROVIDED: 425 S.F.

BUILDING #2: 140 LF X 25' FAÇADE X 12%
REQUIRED: 420 S.F.
PROVIDED: 550 S.F.

STREETYARD REQUIREMENT: 18' (9' MIN & 27' MAX WIDTH)
REQUIRED: 354'-94.5' = 259.5' X 18'= 4,671 S.F.
PROVIDED: 5,133 S.F.

ESTIMATED TRIP GENERATION (Per Trip Generation Manual, 10th Edition):
6 RESIDENTIAL UNITS (ITE CODE 231)
AM PEAK: 2 PM PEAK: 2 DAILY: 25

5,200 SF OFFICE (ITE CODE 710)
AM PEAK: 6 PM PEAK: 6 DAILY: 51

PROJECT TOTAL AM PEAK: 8 PM PEAK: 8 DAILY: 76

EXISTING SEWER AND WATER DEMAND: 480 GPD

PROPOSED SEWER AND WATER DEMAND: 1,740 GPD

DEVELOPMENT NOTES:

- ALL DEVELOPMENT SHALL BE IN ACCORDANCE WITH THE CITY OF WILMINGTON LAND DEVELOPMENT CODE.
- PROJECT SHALL COMPLY WITH ALL FEDERAL, STATE & NEW HANOVER COUNTY REGULATIONS.
- ALL ROOF RUNOFF TO BE DIRECTED TO INFILTRATION SYSTEM. ROOF DOWNSPOUTS TO BE COORDINATED WITH ENGINEER FOR APPROPRIATE DIRECTION TO DESIGNED SYSTEM. SEE ROOF DRAIN CONNECTION PROVIDED AT REAR SIDEWALK.
- SURVEYOR TO VERIFY COD RESOURCE AND SETBACK LINE BEFORE RECORDING EASEMENT.


FIRE & SAFETY NOTES:

- CONSTRUCTION TYPE: V-B (COMMERCIAL)
- PROPOSED BUILDING WILL NOT BE SPRINKLED.
- PARKING AND LANDSCAPING CANNOT BLOCK FIRE HYDRANTS.
- ALL WEATHER ACCESS ROAD MUST BE MAINTAINED AROUND CONSTRUCTION SITE AT ALL TIMES.
- HIGHWAY GUARDRAILS SHALL BE OF SUFFICIENT NUMBERS TO ACCOMMODATE BASE FIRE FLOW REQUIREMENTS OF STRUCTURE.
- IN ADDITION TO THE STANDARD COMMENTS, ADDITIONAL FIRE PROTECTION AND ACCESSIBILITY REQUIREMENTS MAY BE REQUIRED DUE TO ANY SPECIAL CIRCUMSTANCES CONCERNING THE PROJECT.
- CONTRACTOR SHALL SUBMIT A RADIO SIGNAL STRENGTH STUDY FOR ALL COMMERCIAL BUILDINGS ON THE SITE THAT DEMONSTRATES THAT EXISTING EMERGENCY RESPONDER RADIO SIGNAL LEVELS MEET THE REQUIREMENTS OF SECTION 510 of the 2018 NC FIRE CODE.





Approved Construction Plan
Date: 10/19/20
2020031
SWP #: 2020031
PO, ES, BM, MB, CW

GENERAL TRAFFIC NOTES:

- ALL TRAFFIC CONTROL SIGNS AND PAVEMENT MARKINGS OFF THE R/W TO BE MAINTAINED BY THE PROPERTY OWNER IN ACCORDANCE WITH MUTCD STANDARDS.
- ALL PAVEMENT MARKINGS IN PUBLIC RIGHTS-OF-WAY AND FOR DRIVEWAYS ARE TO BE THERMOPLASTIC AND MEET CITY AND/OR NCDDT STANDARDS. [DETAIL SD 15-13 & SD 11-3 COWF TECH STD'S]
- ALL SIGNS AND PAVEMENT MARKINGS OFF RIGHT OF WAY ARE TO MEET/BE MAINTAINED TO MUTCD (MATERIAL & UNIFORM TRAFFIC CONTROL DEVICES) STANDARDS. [DETAIL SD 15-13 & SD 11-3 COWF TECH STD'S]
- A UTILITY CUT PERMIT IS REQUIRED FOR EACH OPEN CUT OF A CITY STREET. NOTE THIS ON THE PLAN AND CONTACT 341-5899 FOR MORE DETAILS. IN CERTAIN CASES AN ENTIRE RESURFACING OF THE AREA BEING OPEN CUT MAY BE REQUIRED.
- ANY BROKEN OR MISSING SIDEWALK PANELS, DRIVEWAY PANELS AND CURBING WILL BE REPLACED.
- CONTACT 811 PRIOR TO CONTACTING CITY OF WILMINGTON, TRAFFIC ENGINEERING REGARDING THE UTILITIES IN ROW.
- ALL PROPOSED VEGETATION WITHIN SIGHT TRIANGLES SHALL NOT INTERFERE WITH CLEAR VISUAL SIGHT LINES FROM 30' TO 100'.
- STREET LIGHTING SHALL BE LOCATED A MINIMUM OF 15' FEET FROM STREET LIGHTS. [COWF SD 15-17]
- CONTACT TRAFFIC ENGINEERING AT (910) 764-2888 TO DISCUSS STREET LIGHTING OPTIONS.
- A UTILITY CUT PERMIT IS REQUIRED FOR EACH OPEN CUT OF A CITY STREET. NOTE THIS ON THE PLAN AND CONTACT 341-5899 FOR MORE DETAILS. IN CERTAIN CASES AN ENTIRE RESURFACING OF THE AREA BEING OPEN CUT MAY BE REQUIRED.
- CONTRACTOR TO REPAIR/ REPLACE SIGNAL LOOP TO FULL FUNCTIONALITY IN THE EVENT IT GETS CUT.

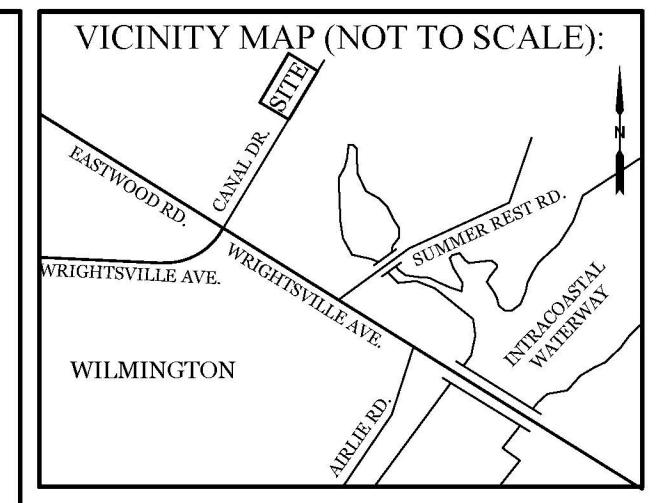








REVISIONS	

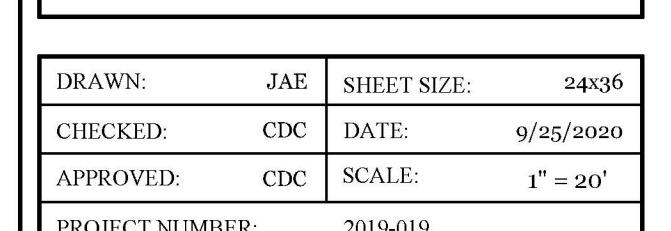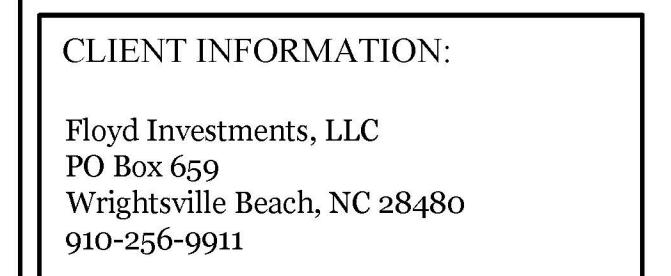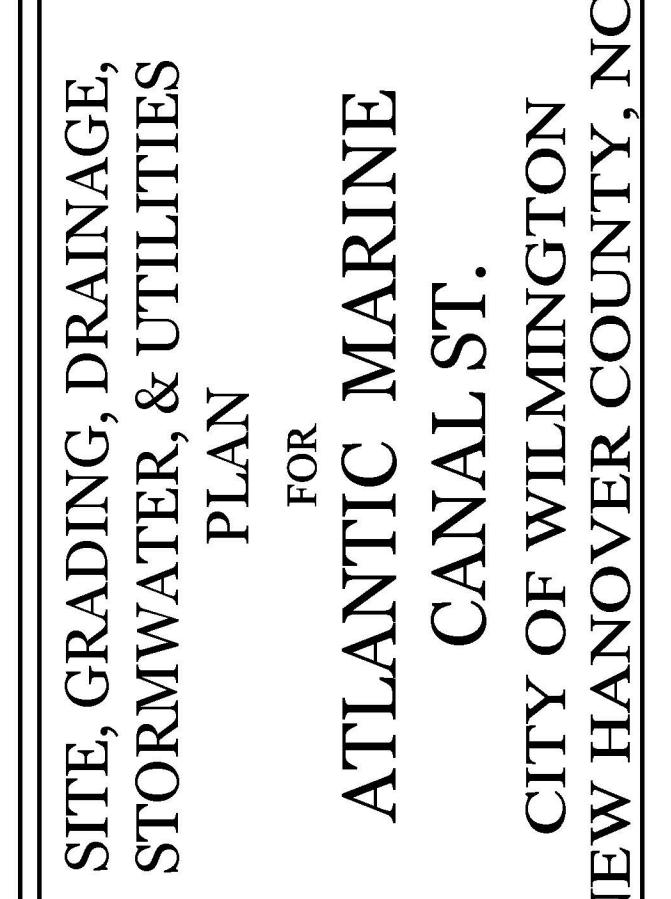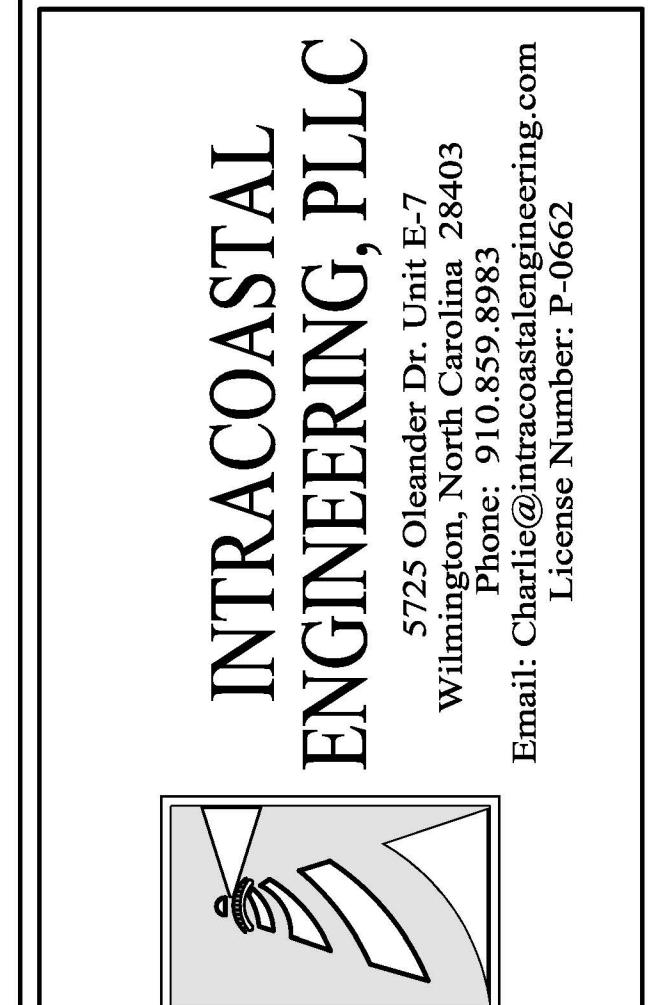

DRAWN: JAE SHEET SIZE: 24x36
CHECKED: CDC DATE: 9/25/2020
APPROVED: CDC SCALE: 1" = 20'
PROJECT NUMBER: 2019-019

DRAWING NUMBER: C-1
Scale: 1"=20'
207




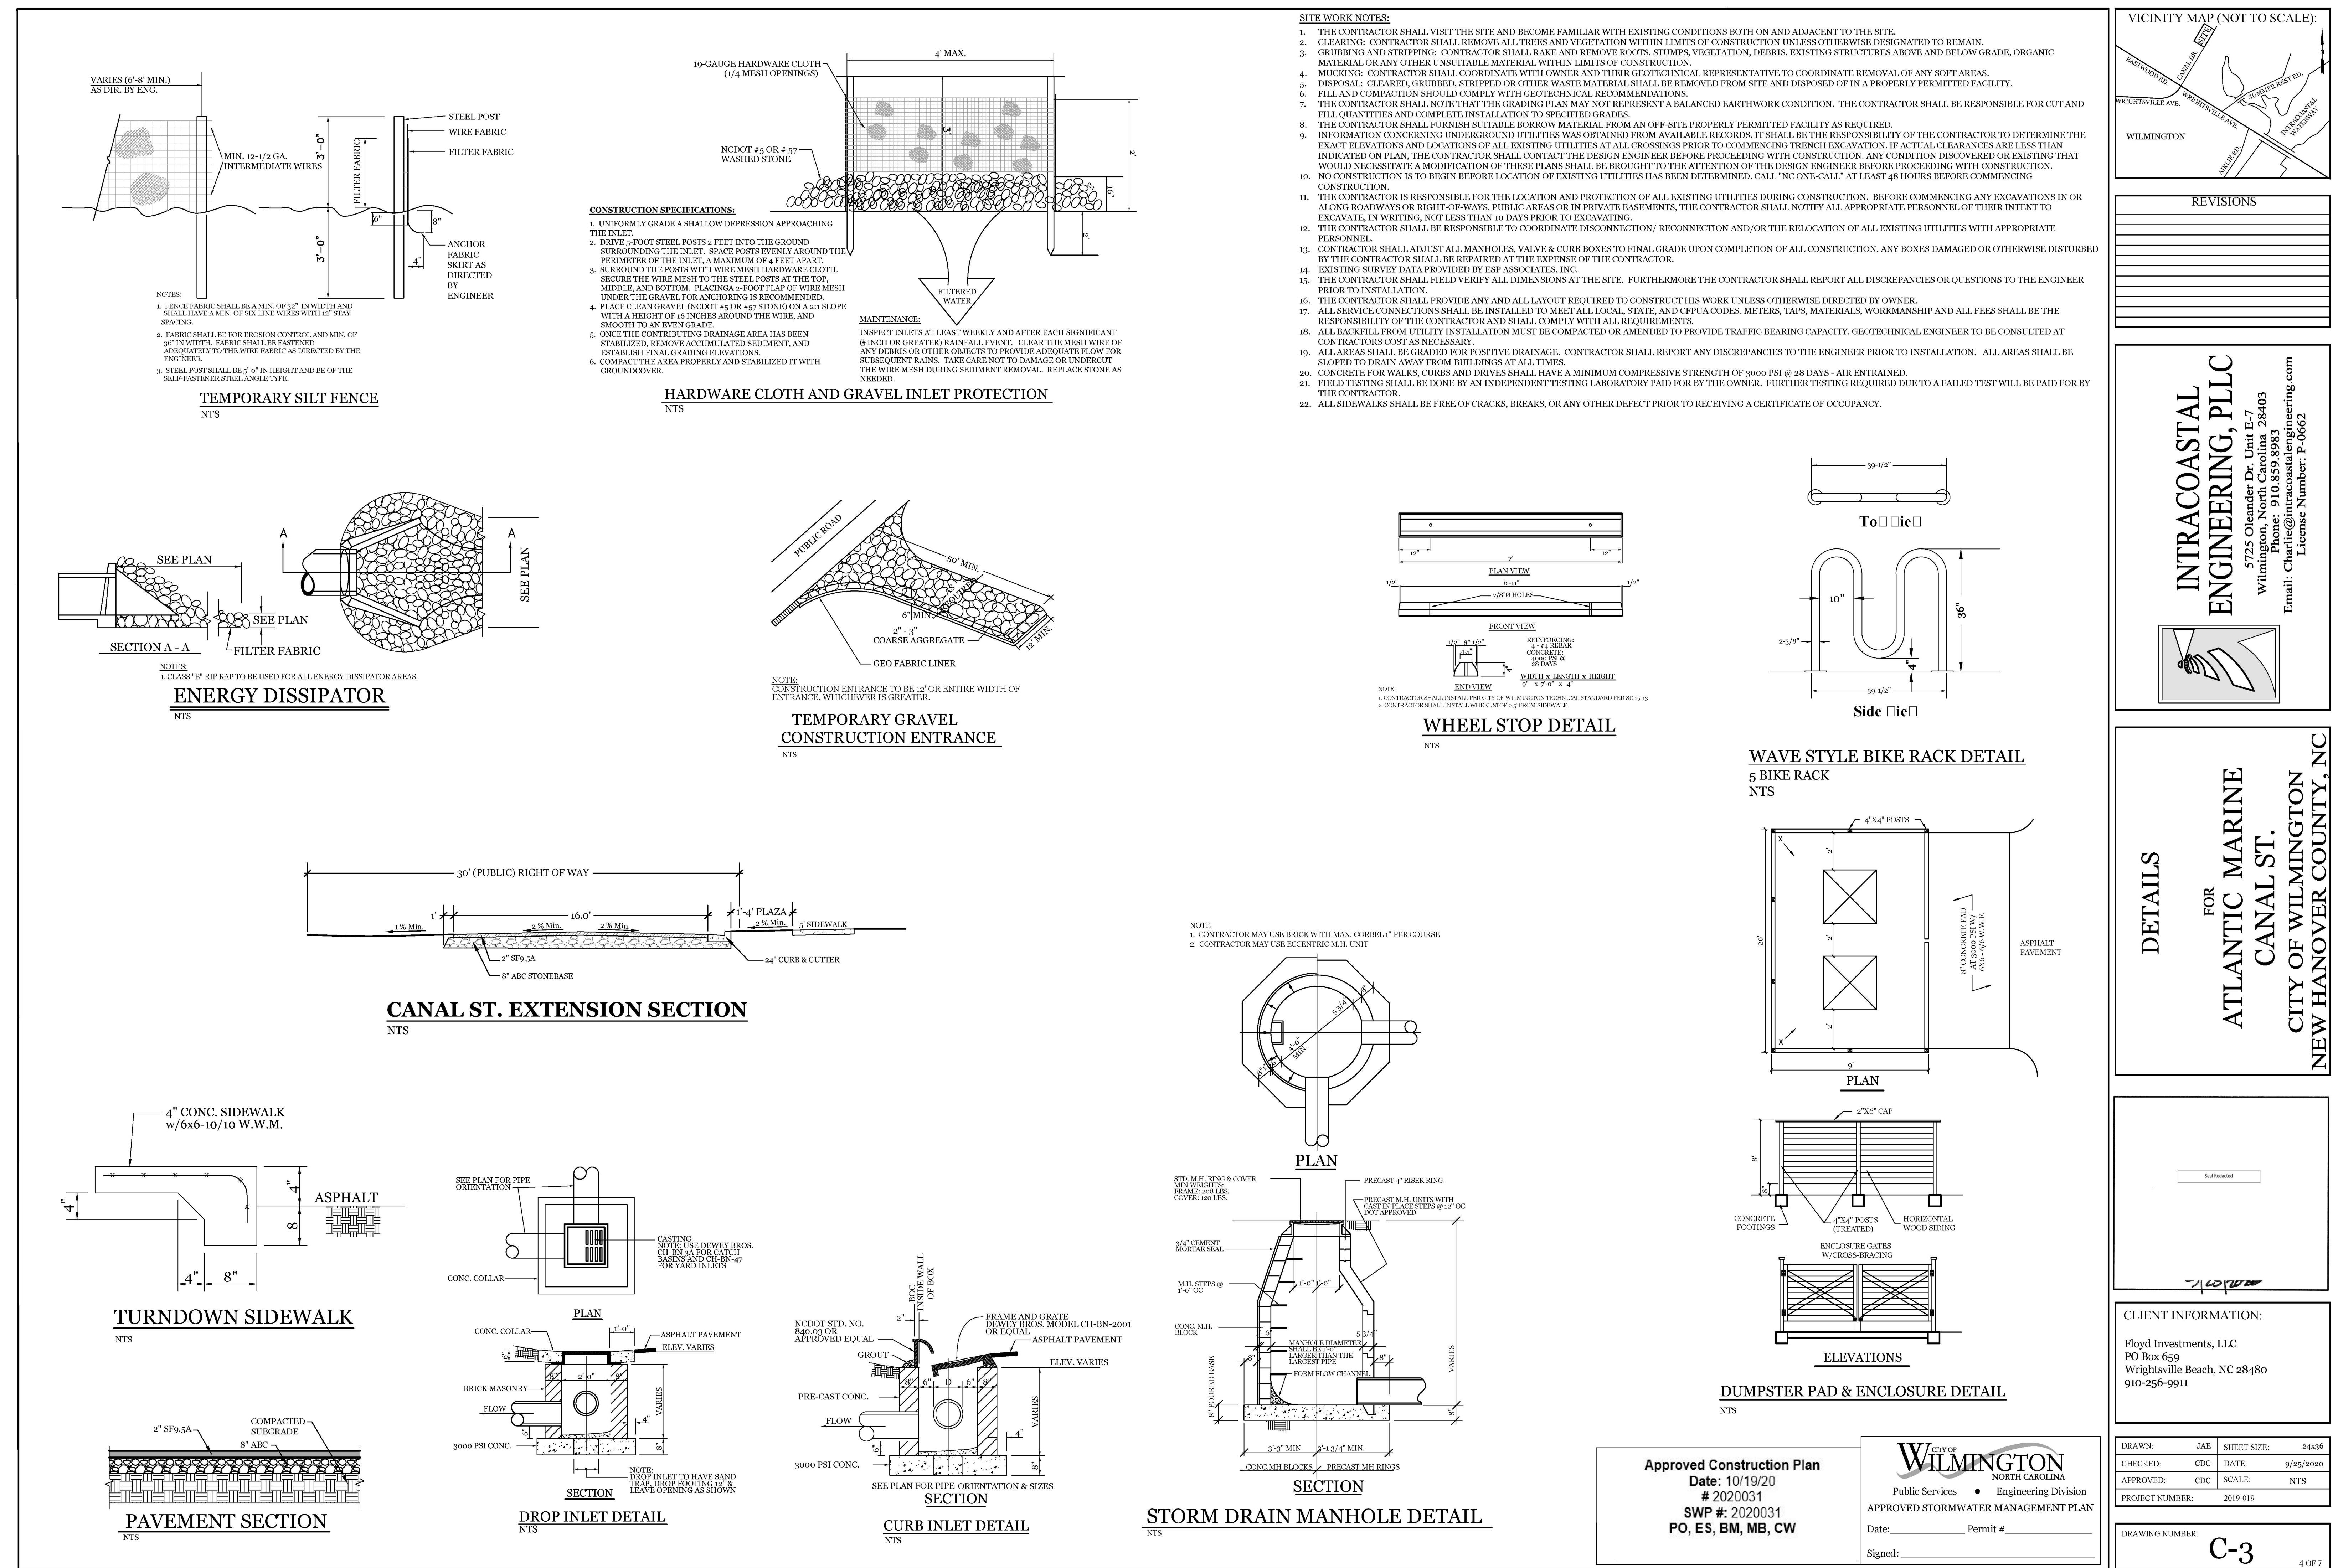


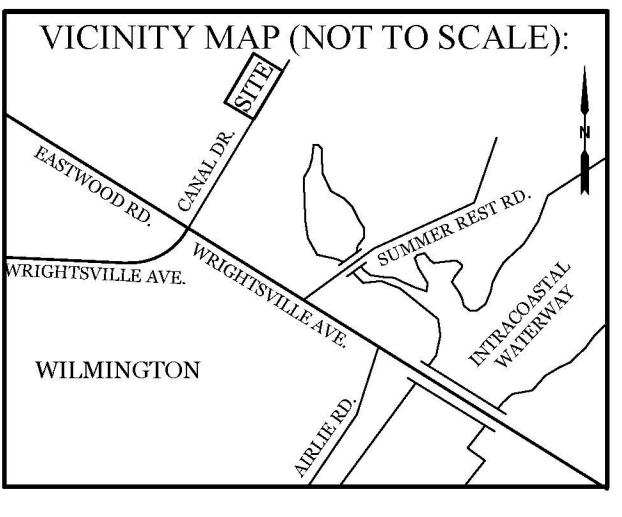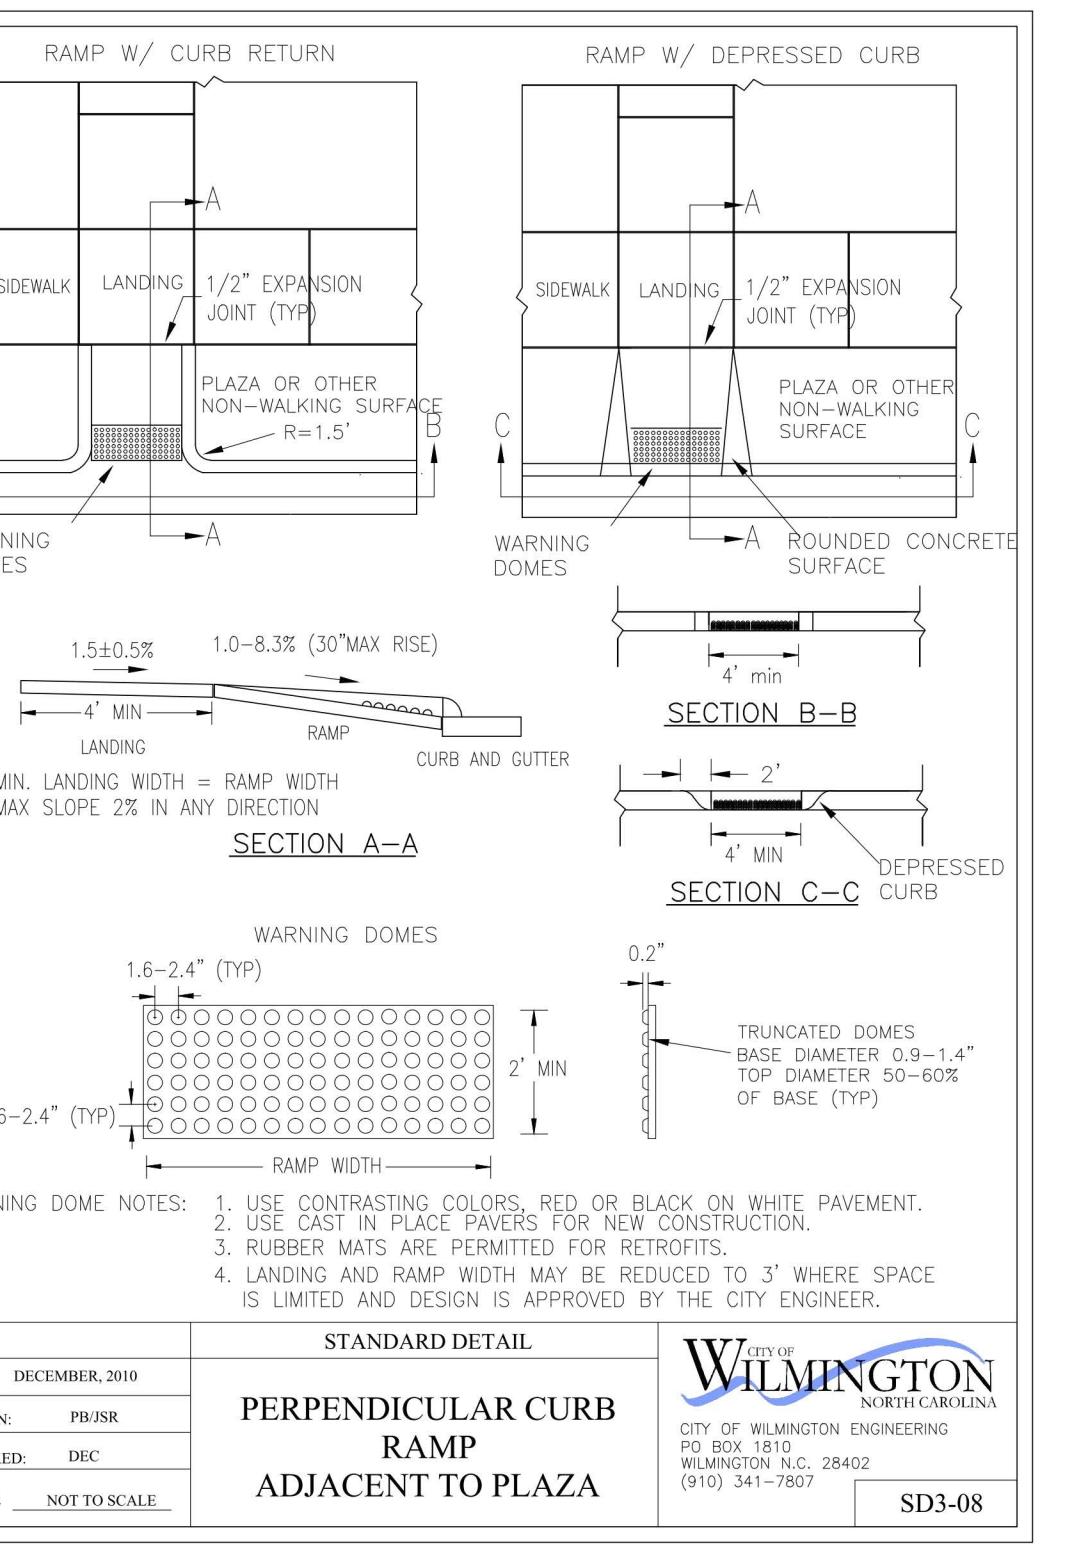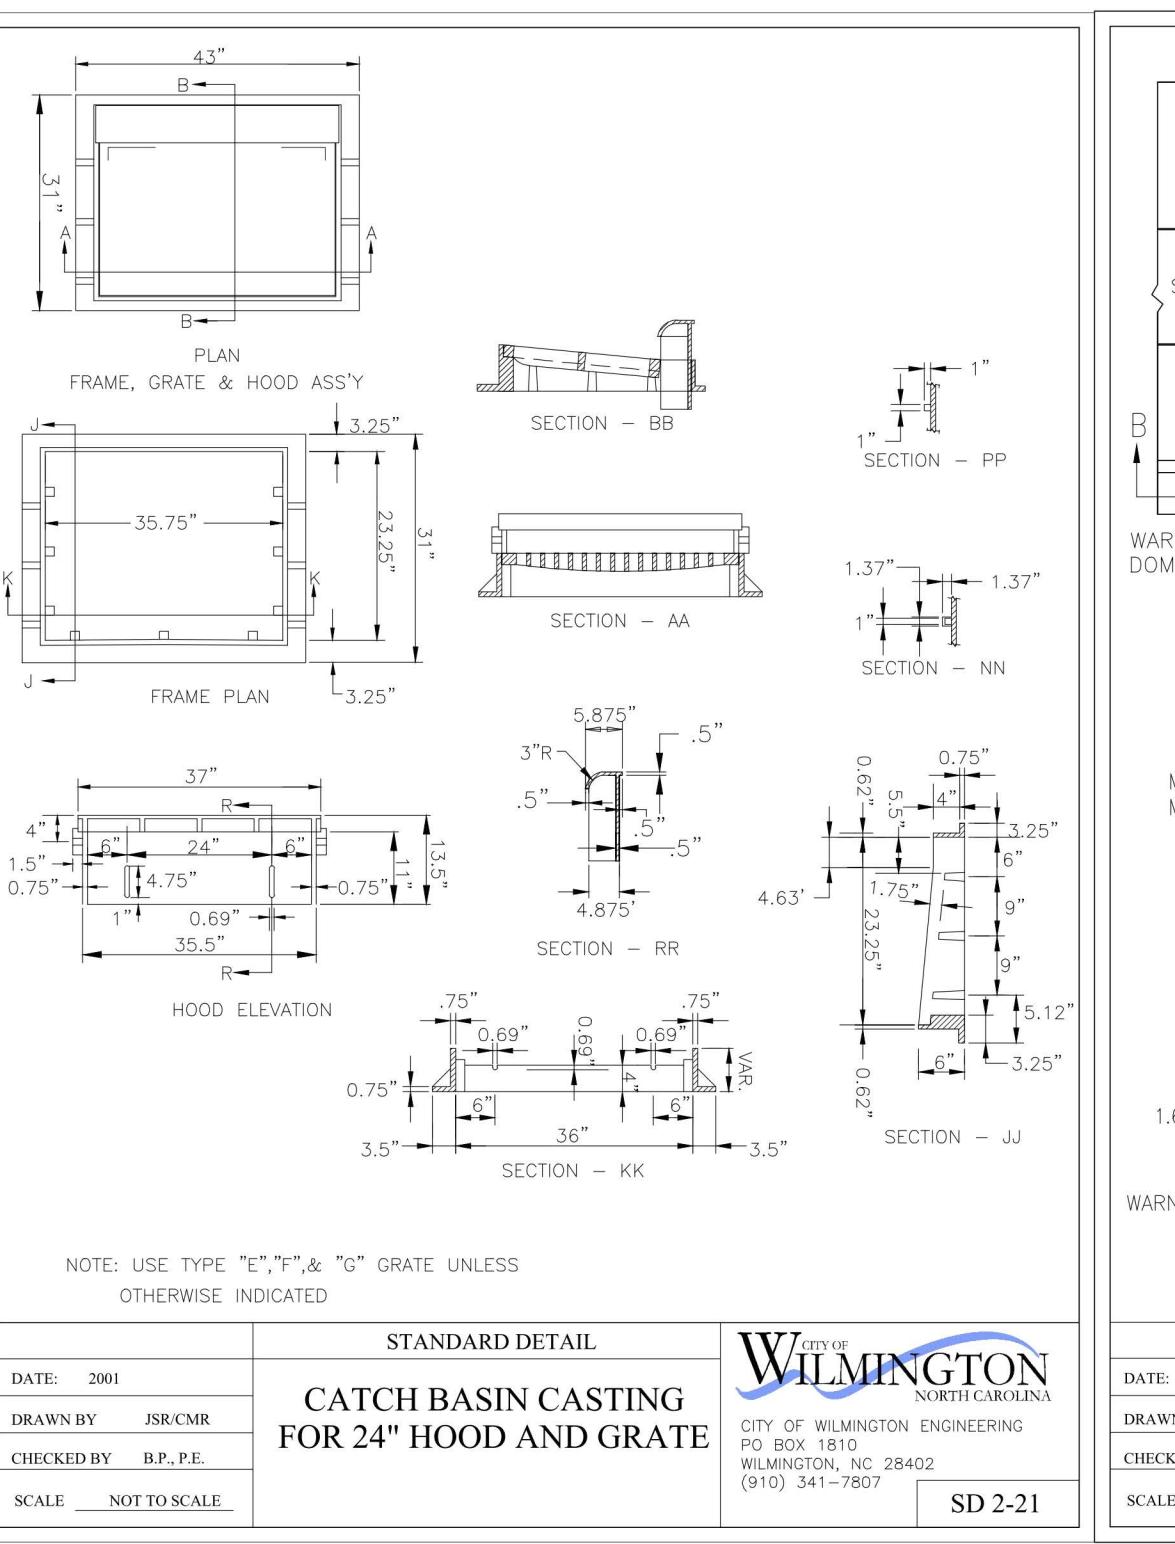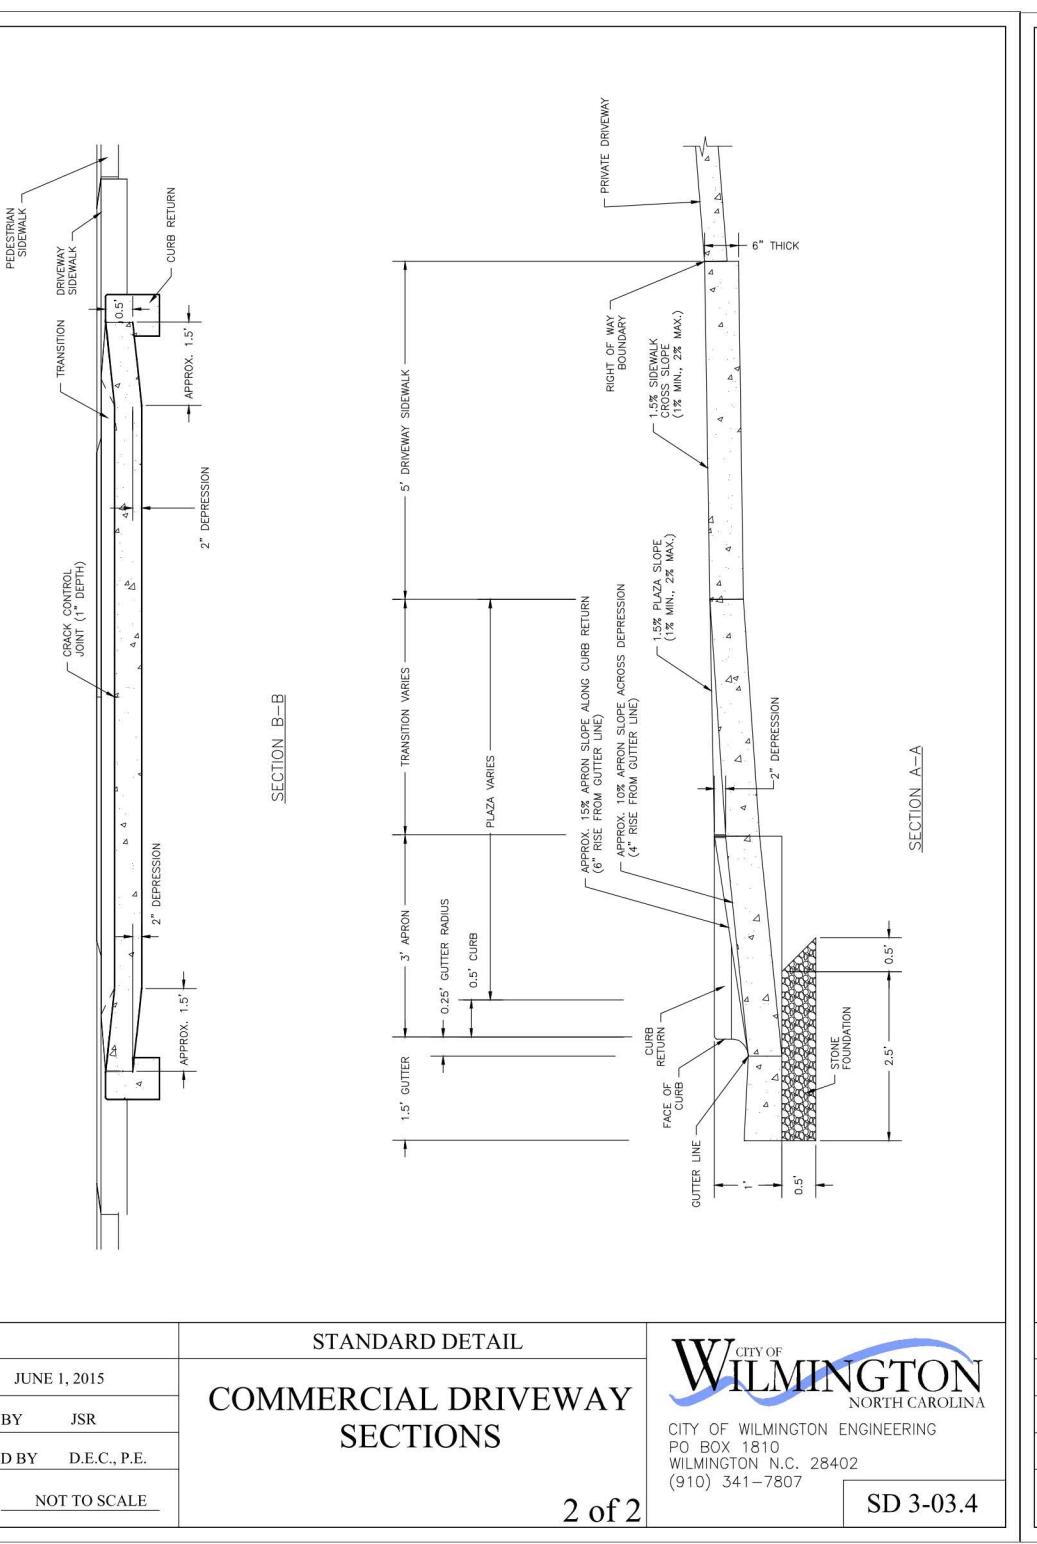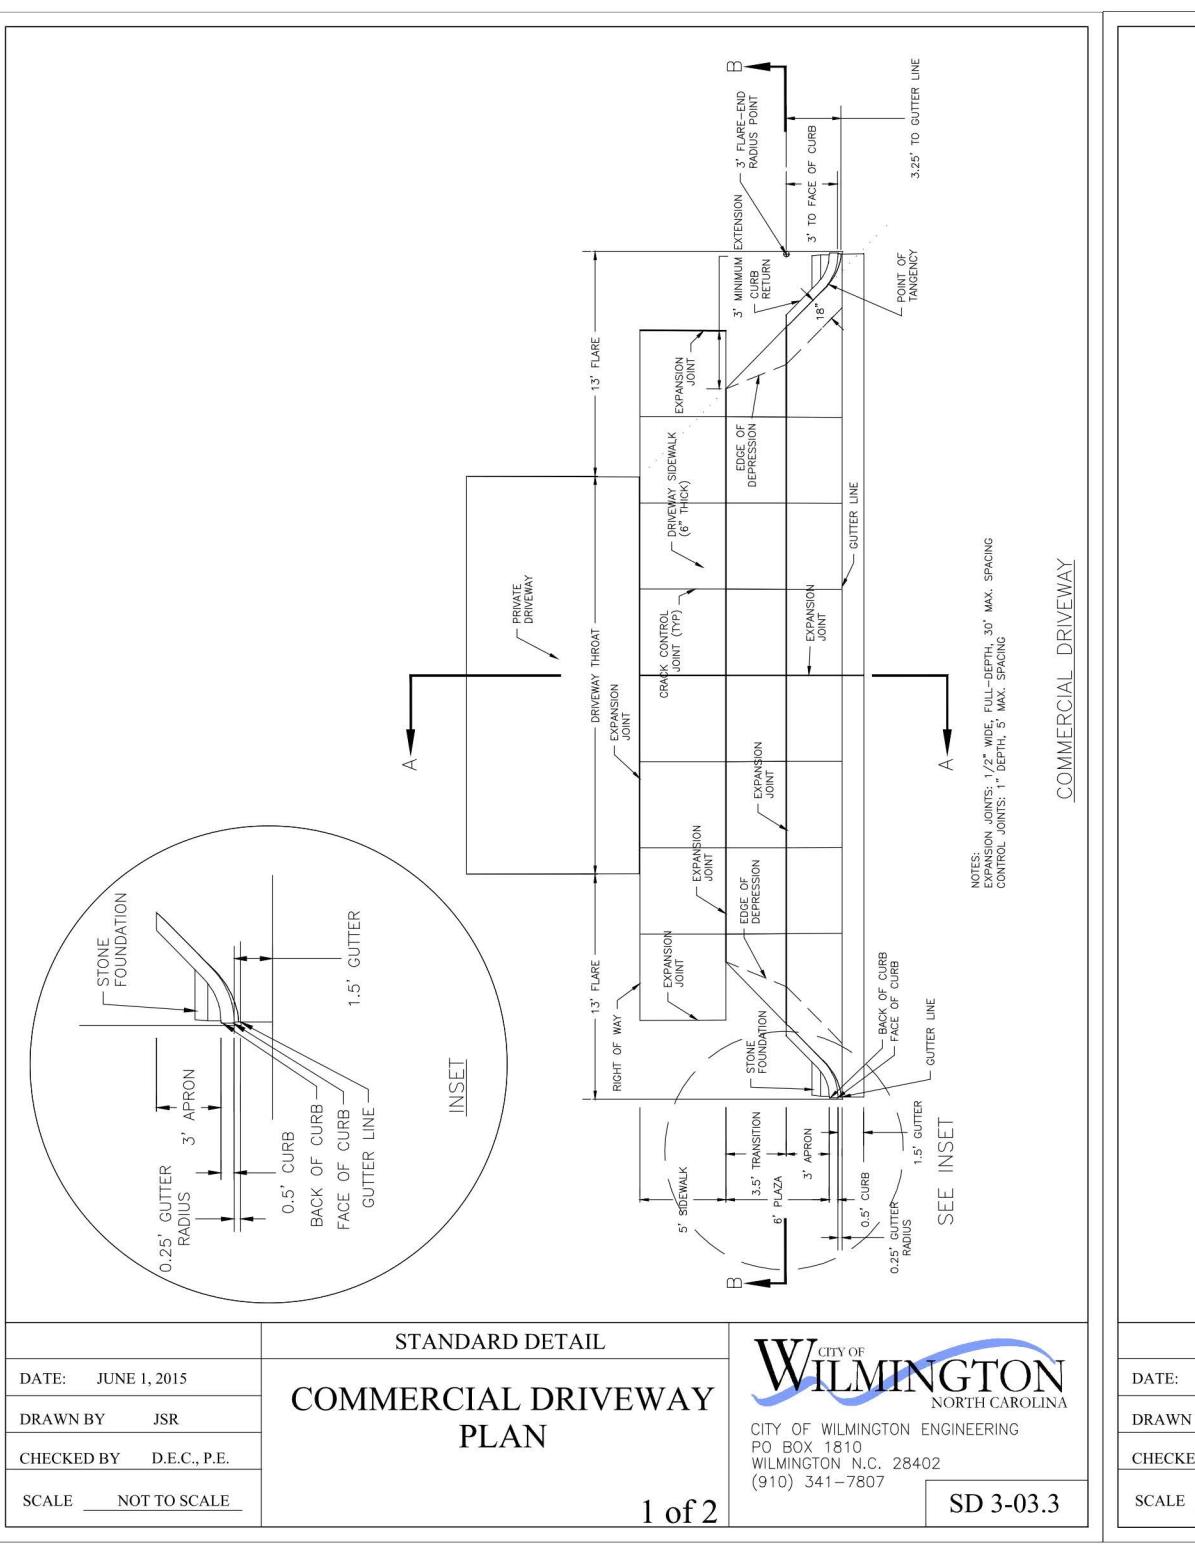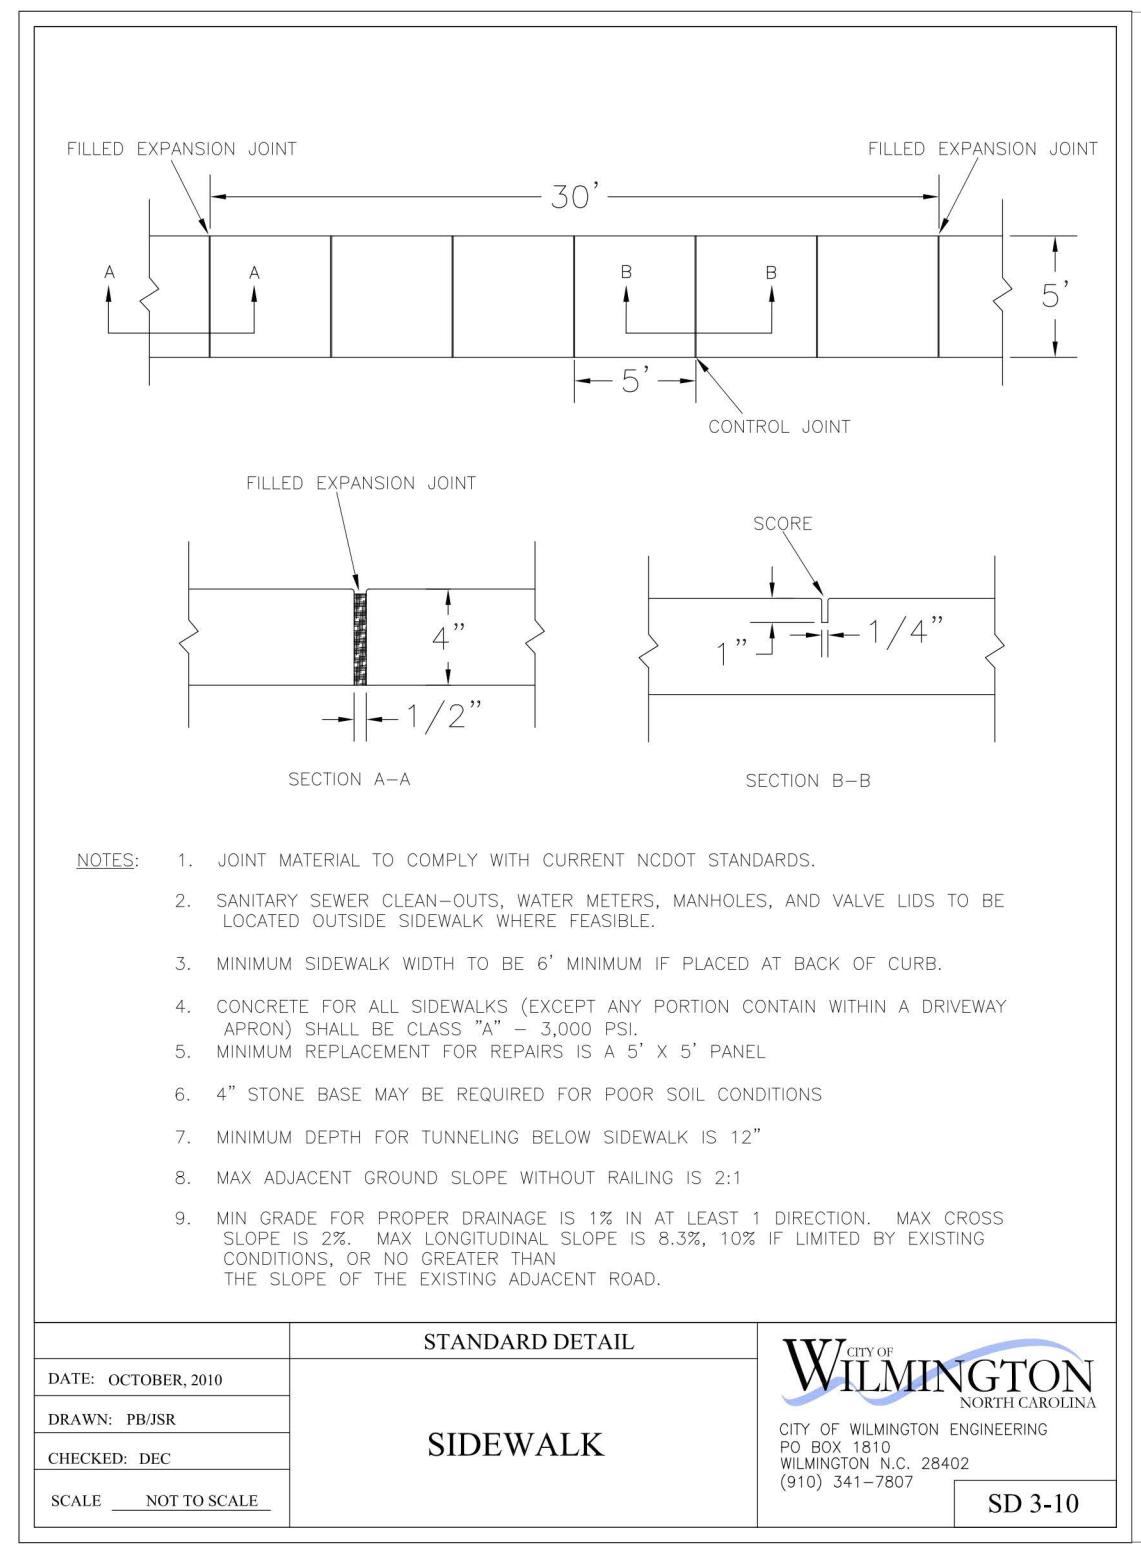

INTRACOASTAL ENGINEERING, PLLC

5725 Oleander Dr. Unit E-7
Wilmington, North Carolina 28403
Phone: 910.859.8983
Email: Charlie@intracoastalengineering.com
License Number: P-0662


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ATLANTIC MAIL

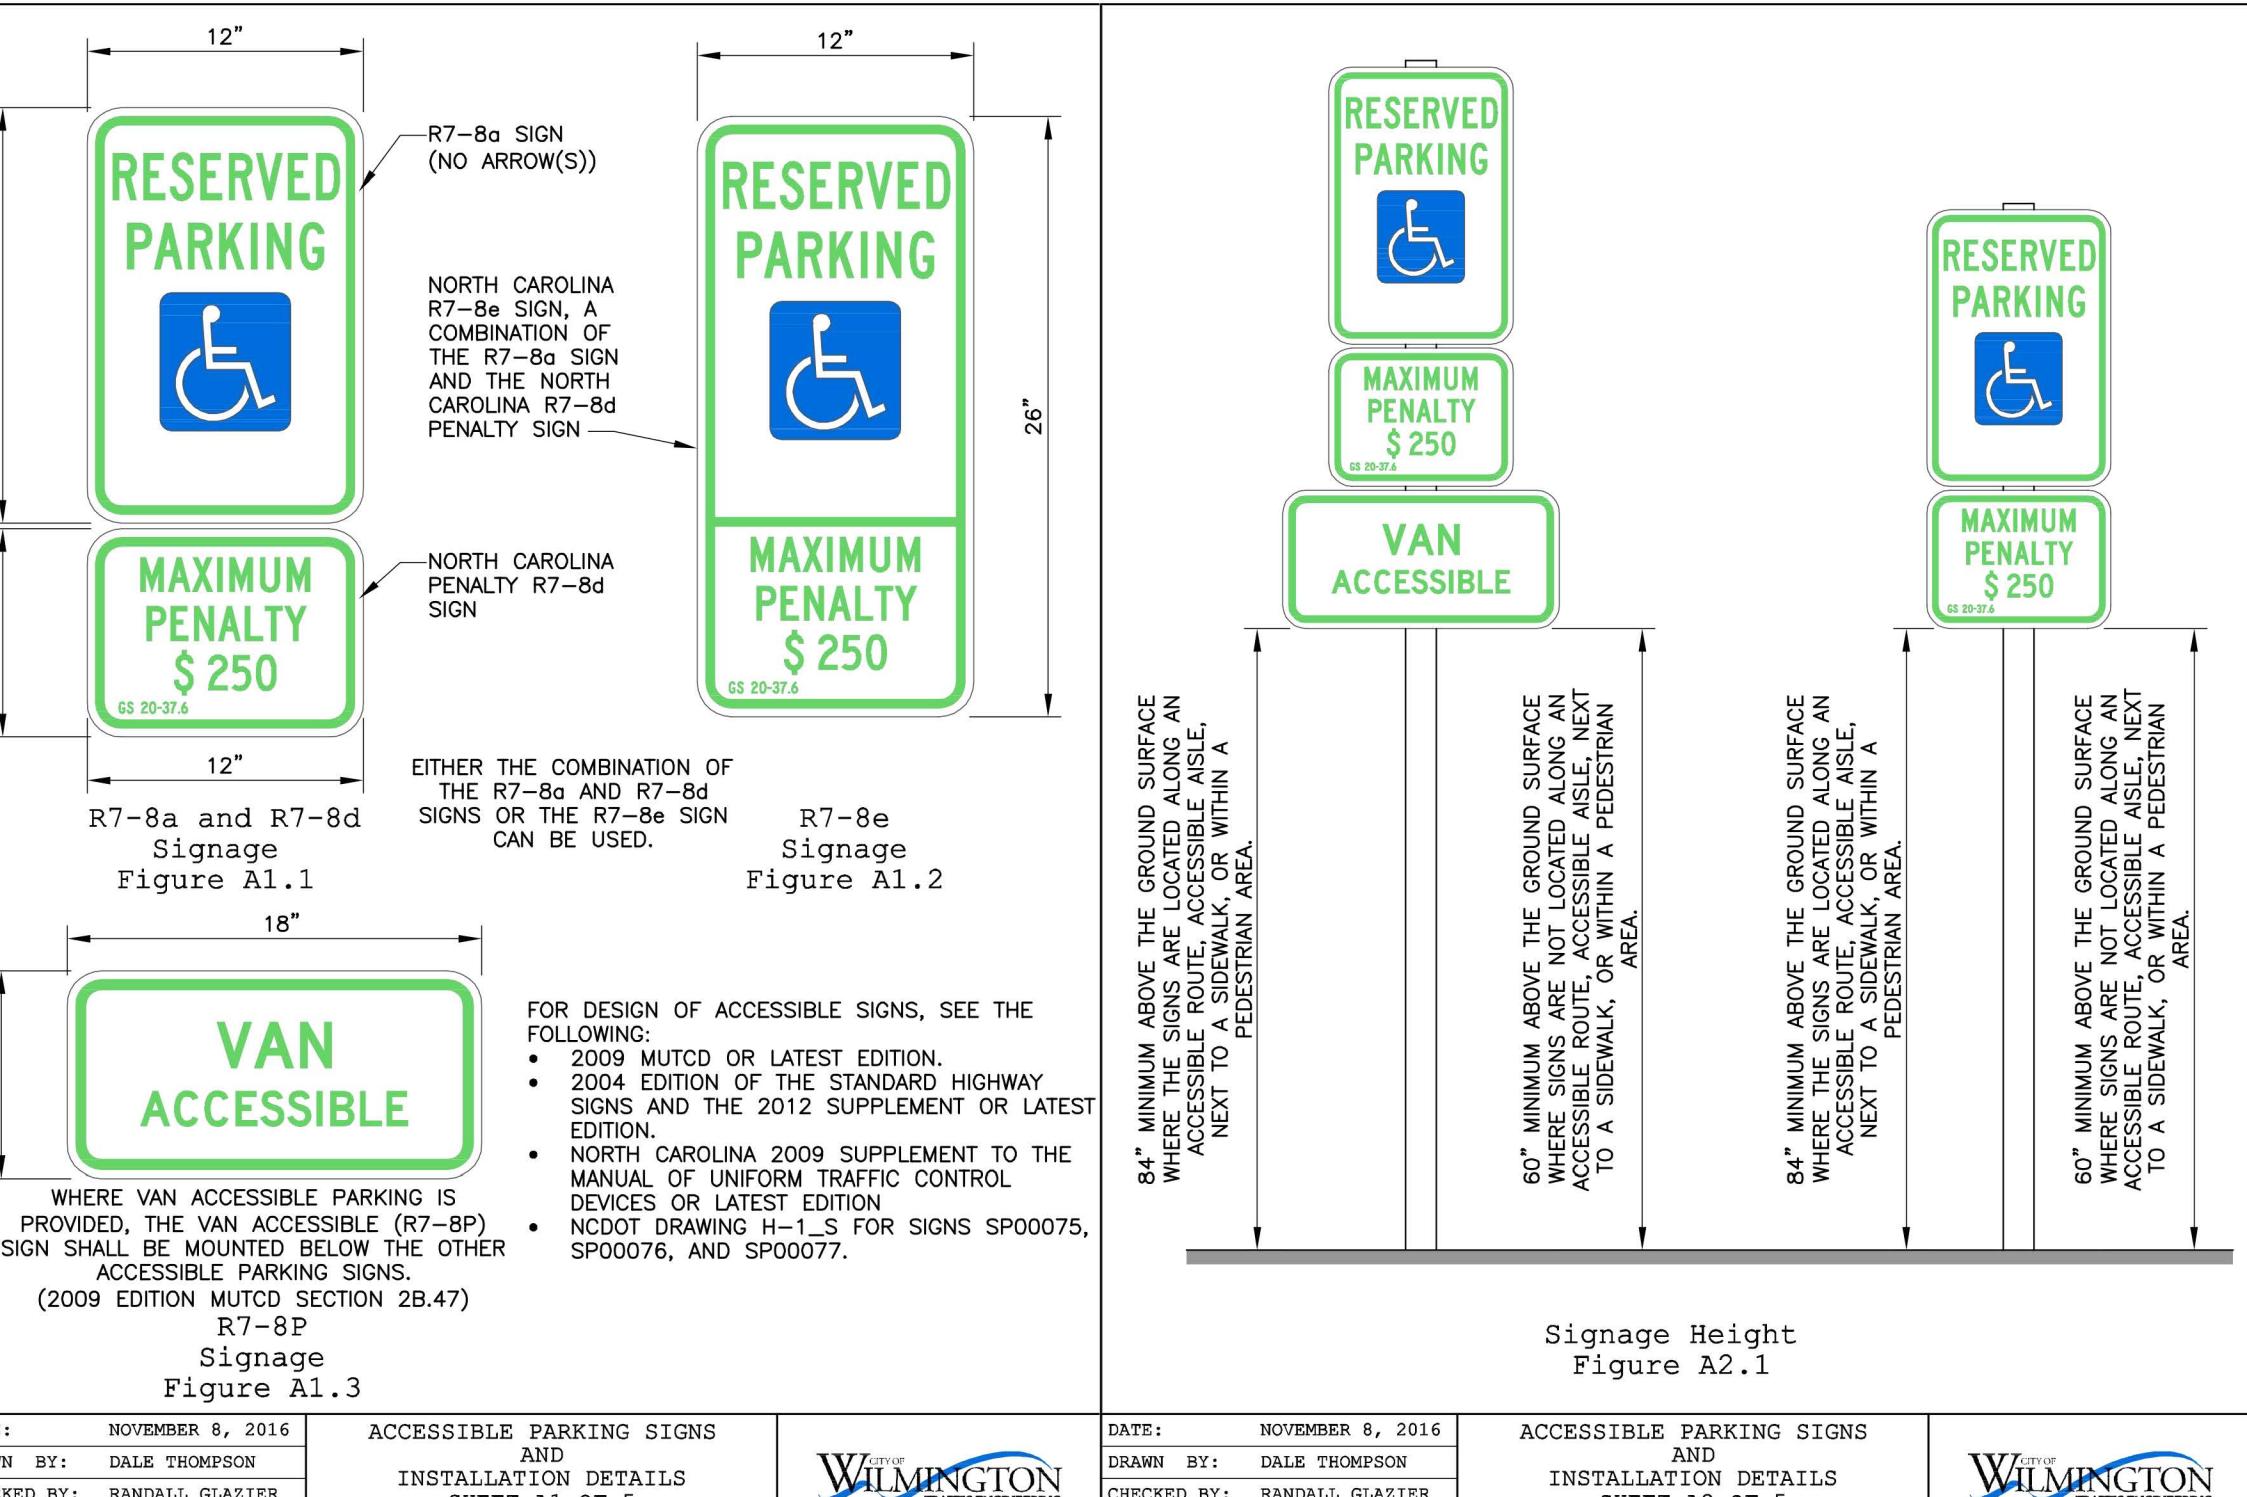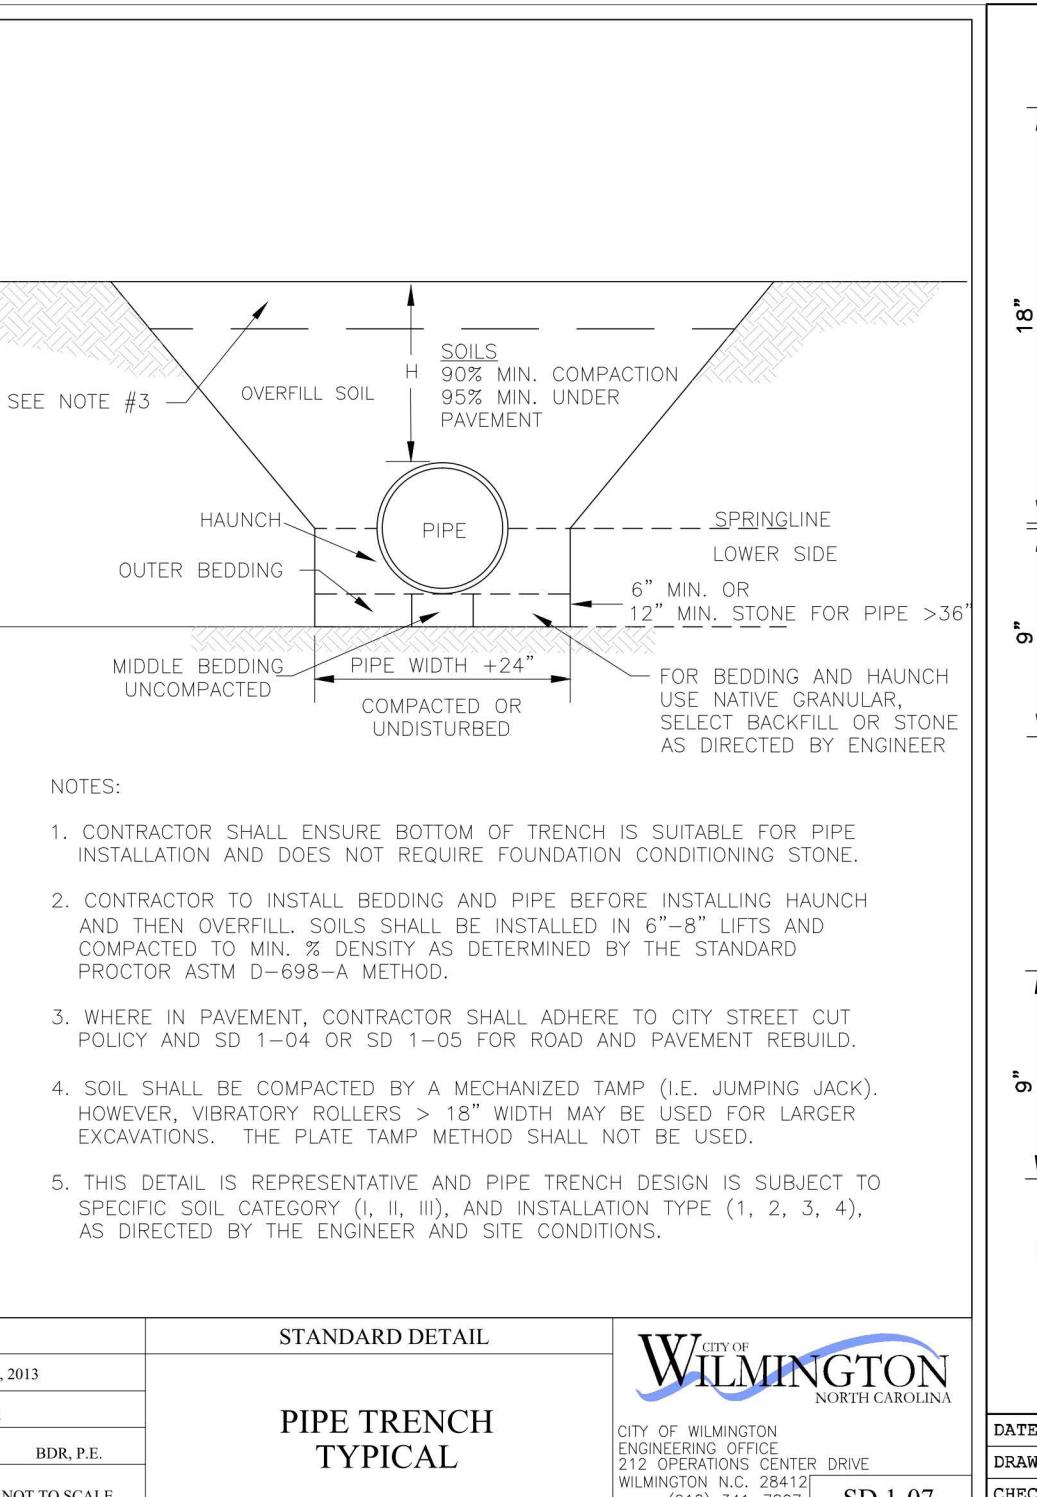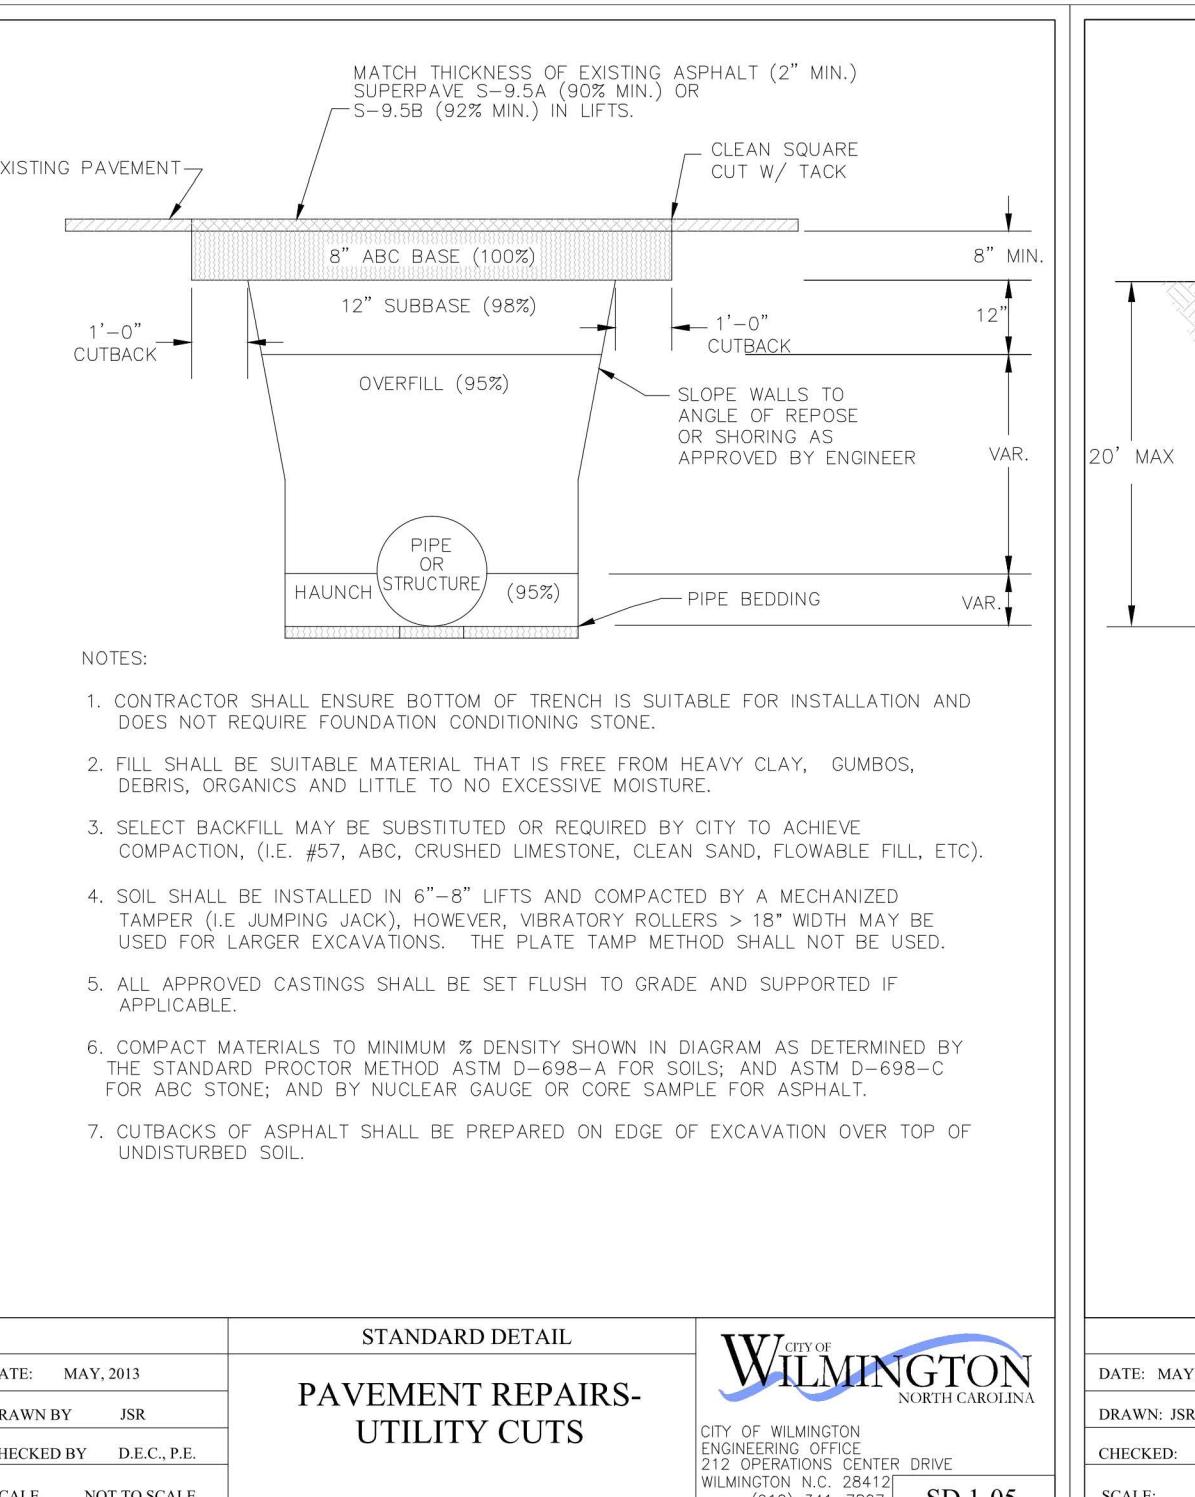
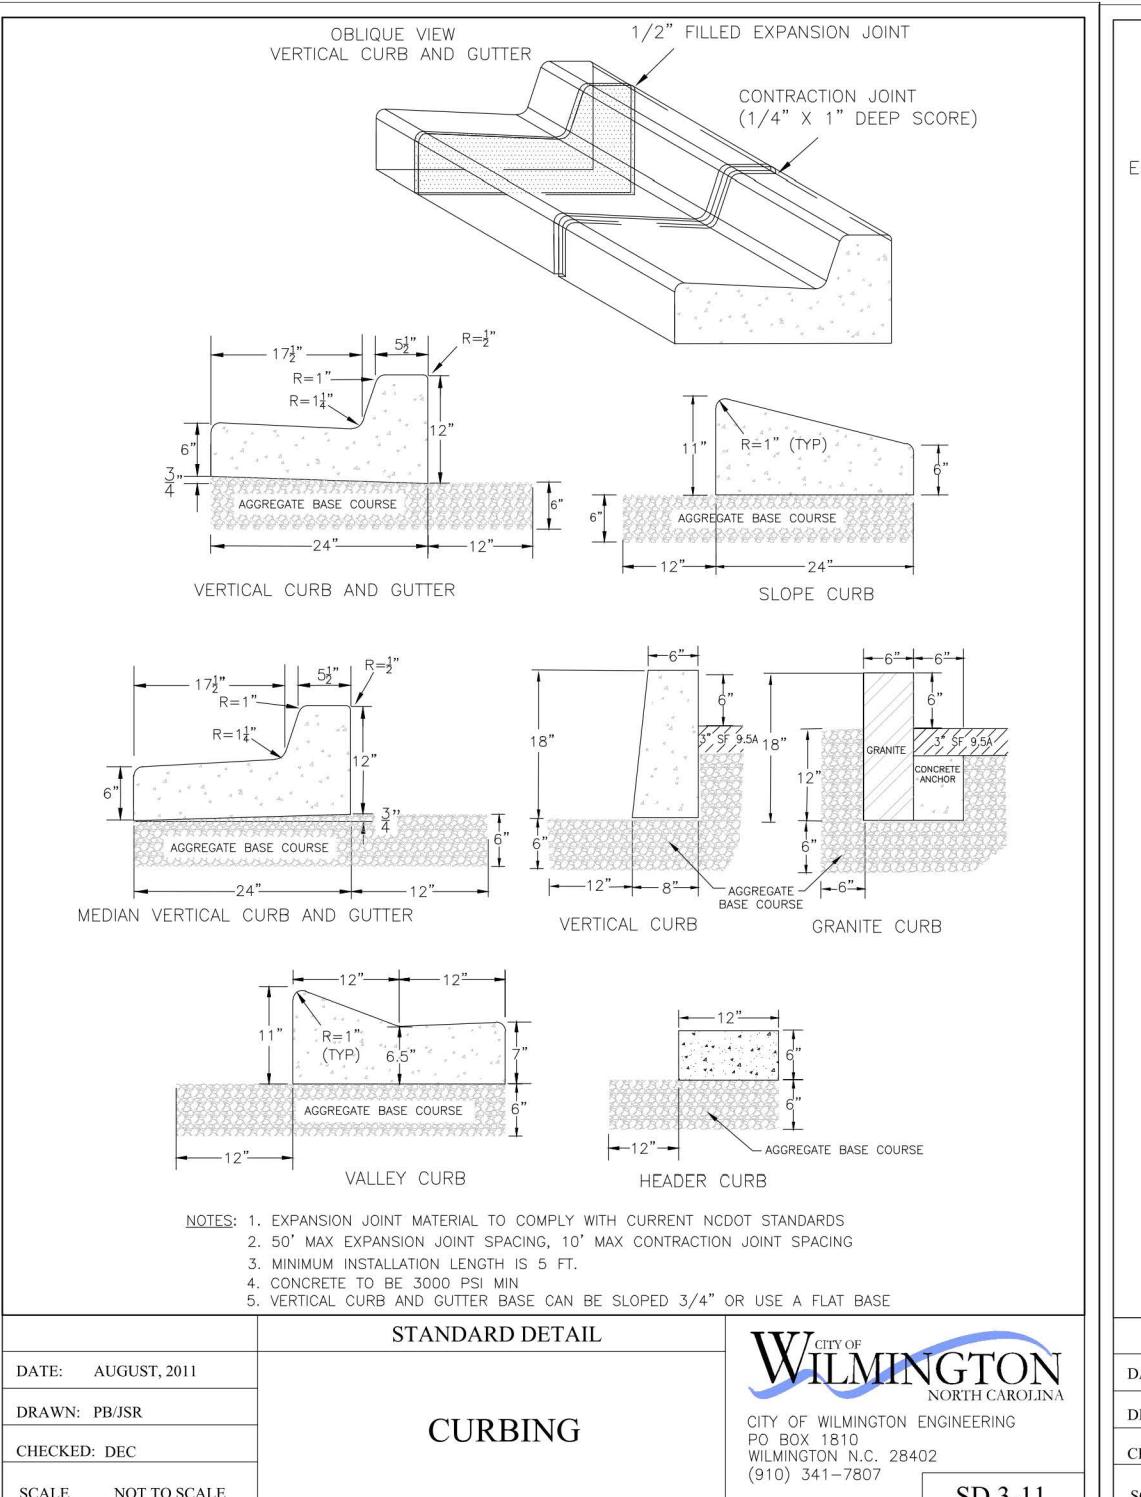
**CITY OF WILMINGTON
CANAL ST.
WILMINGTON**


NEW HANOVER COUNTY, NC



CLIENT INFORMATION:

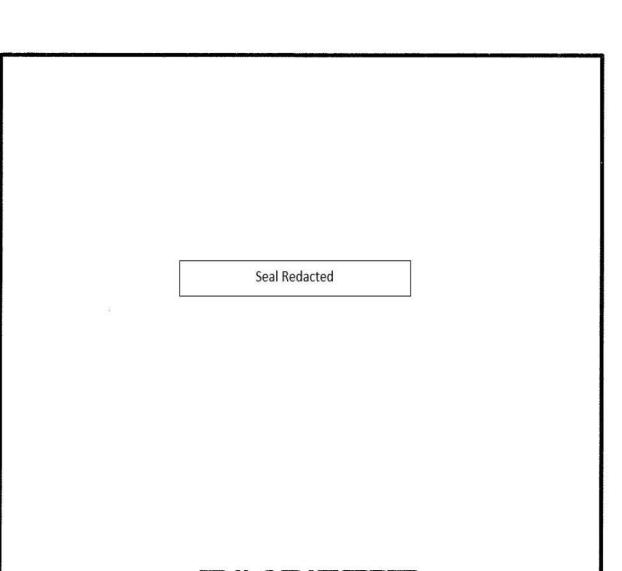
Floyd Investments, LLC
PO Box 659
Wrightsville Beach, NC 28480
910-256-9911

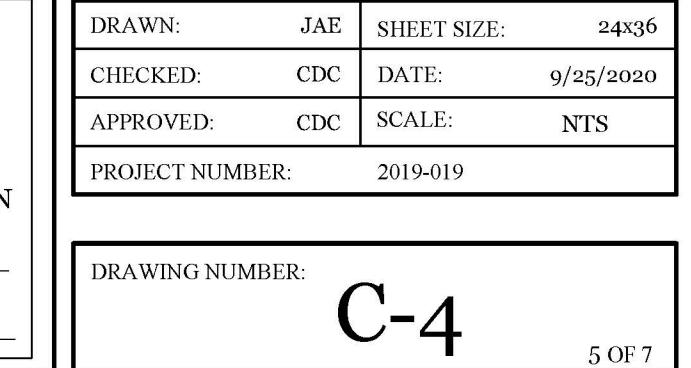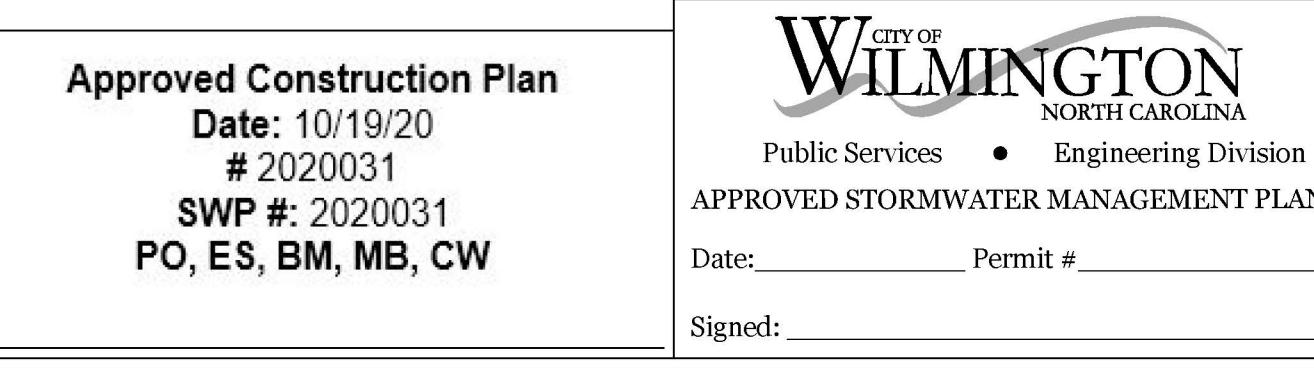

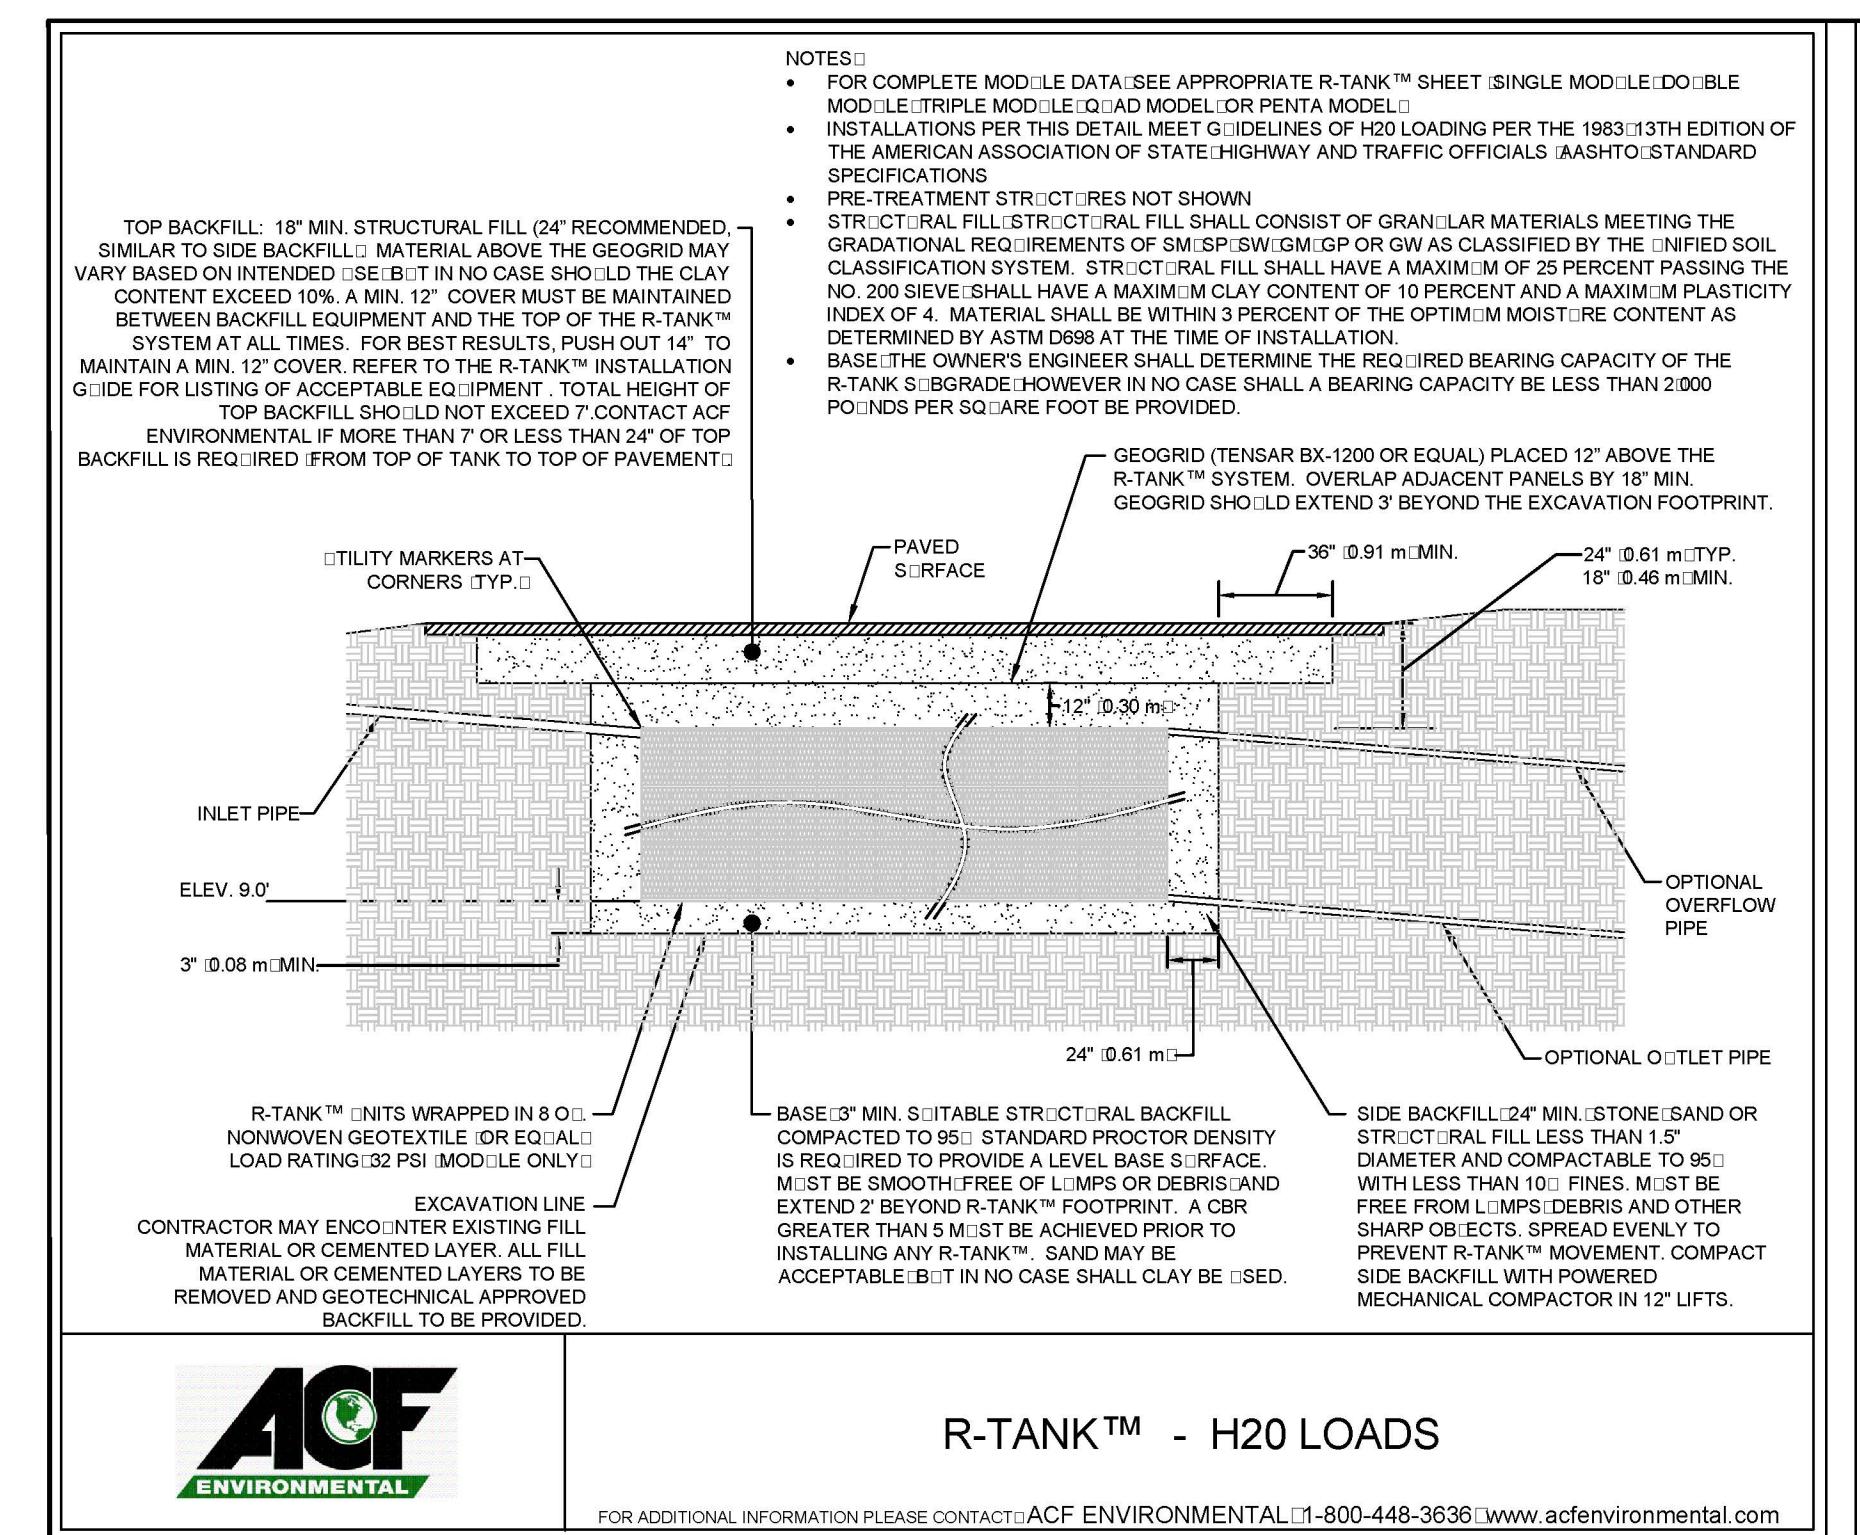


R-TANK™ - H2O LOADS

FOR ADDITIONAL INFORMATION PLEASE CONTACT ACF ENVIRONMENTAL 1-800-448-3636 www.acfenvironmental.com

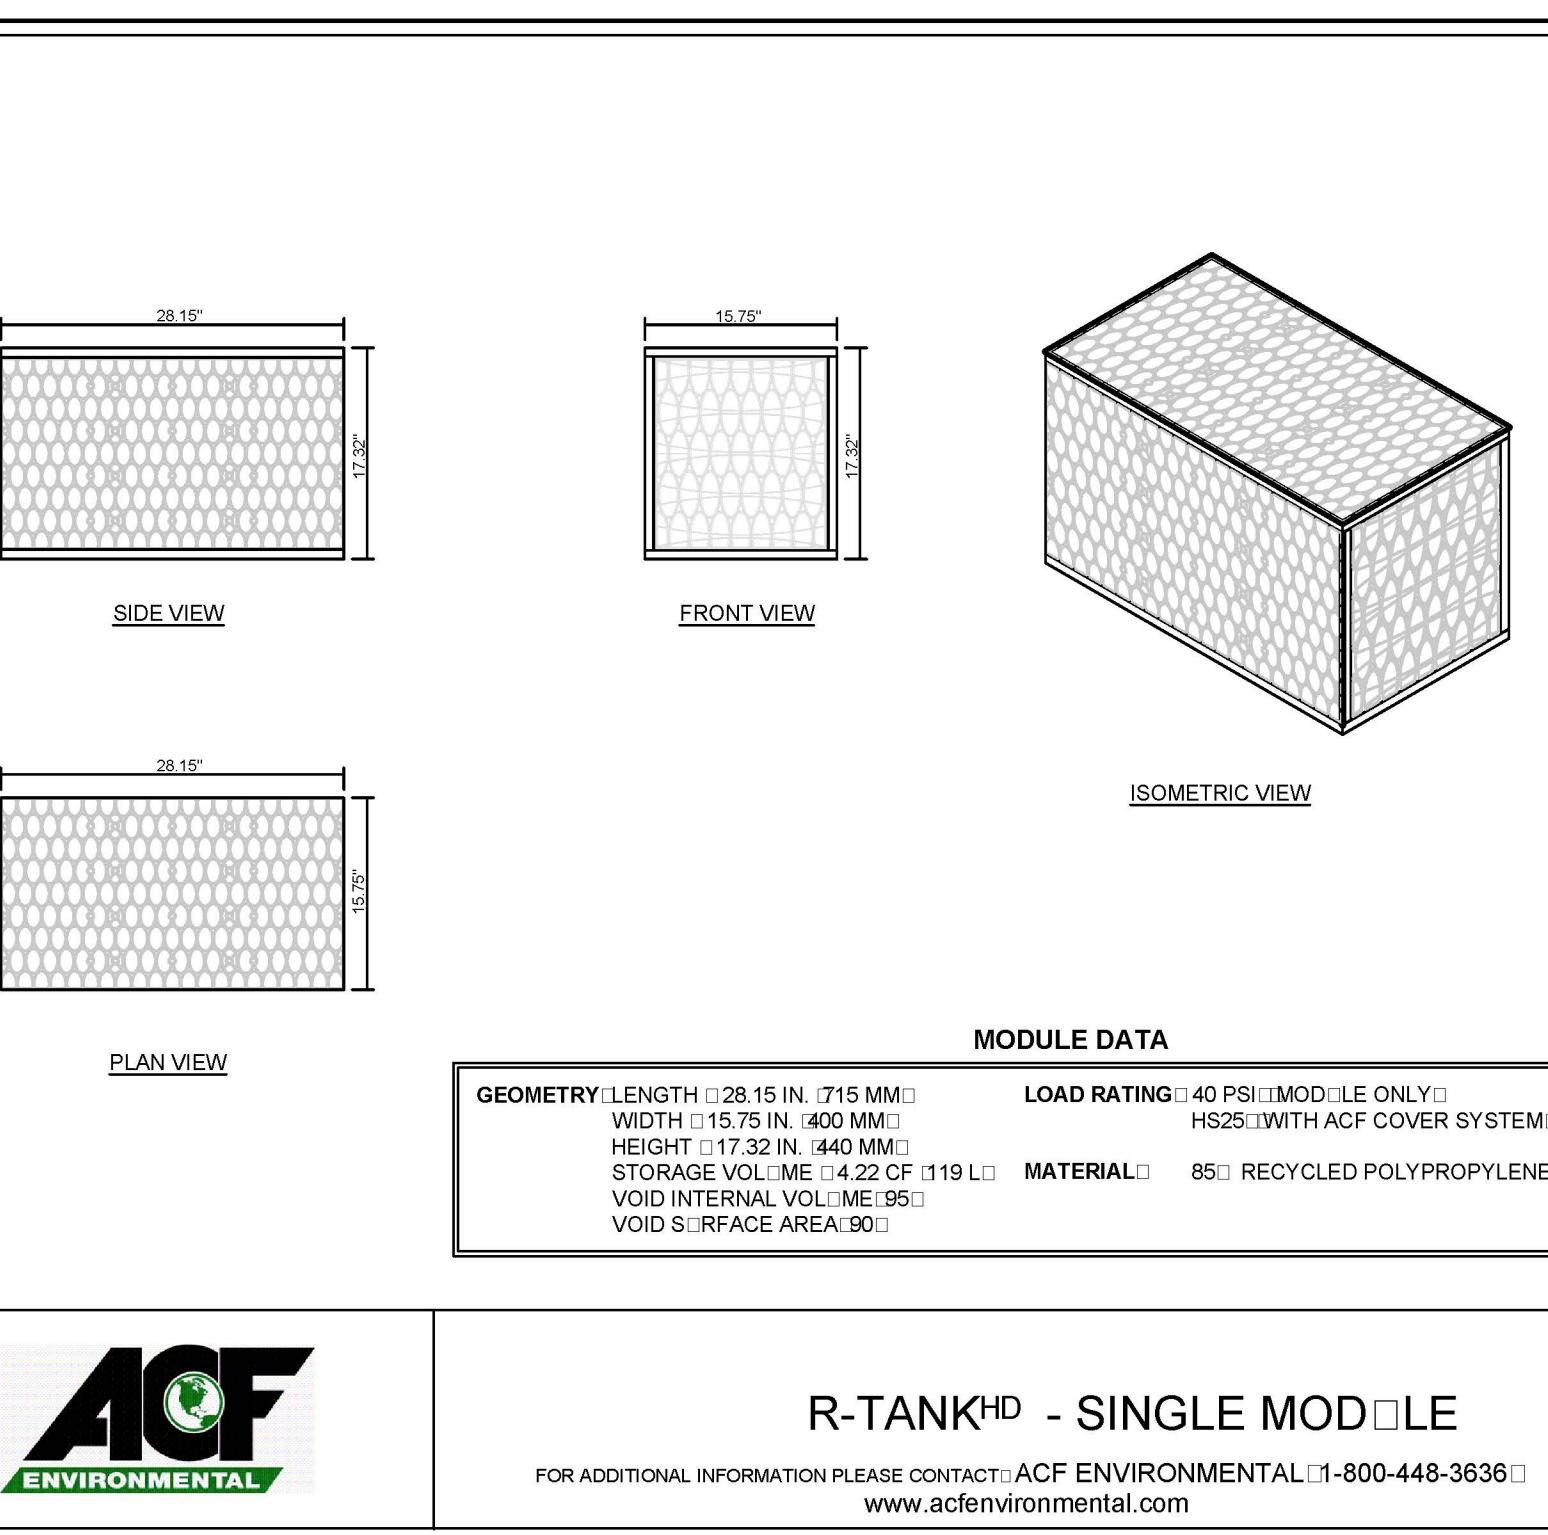


R-TANK^{HD} - SINGLE MODULE

ADDITIONAL INFORMATION PLEASE CONTACT ACF ENVIRONMENTAL 1-800-448-3636
www.acfenvironmental.com



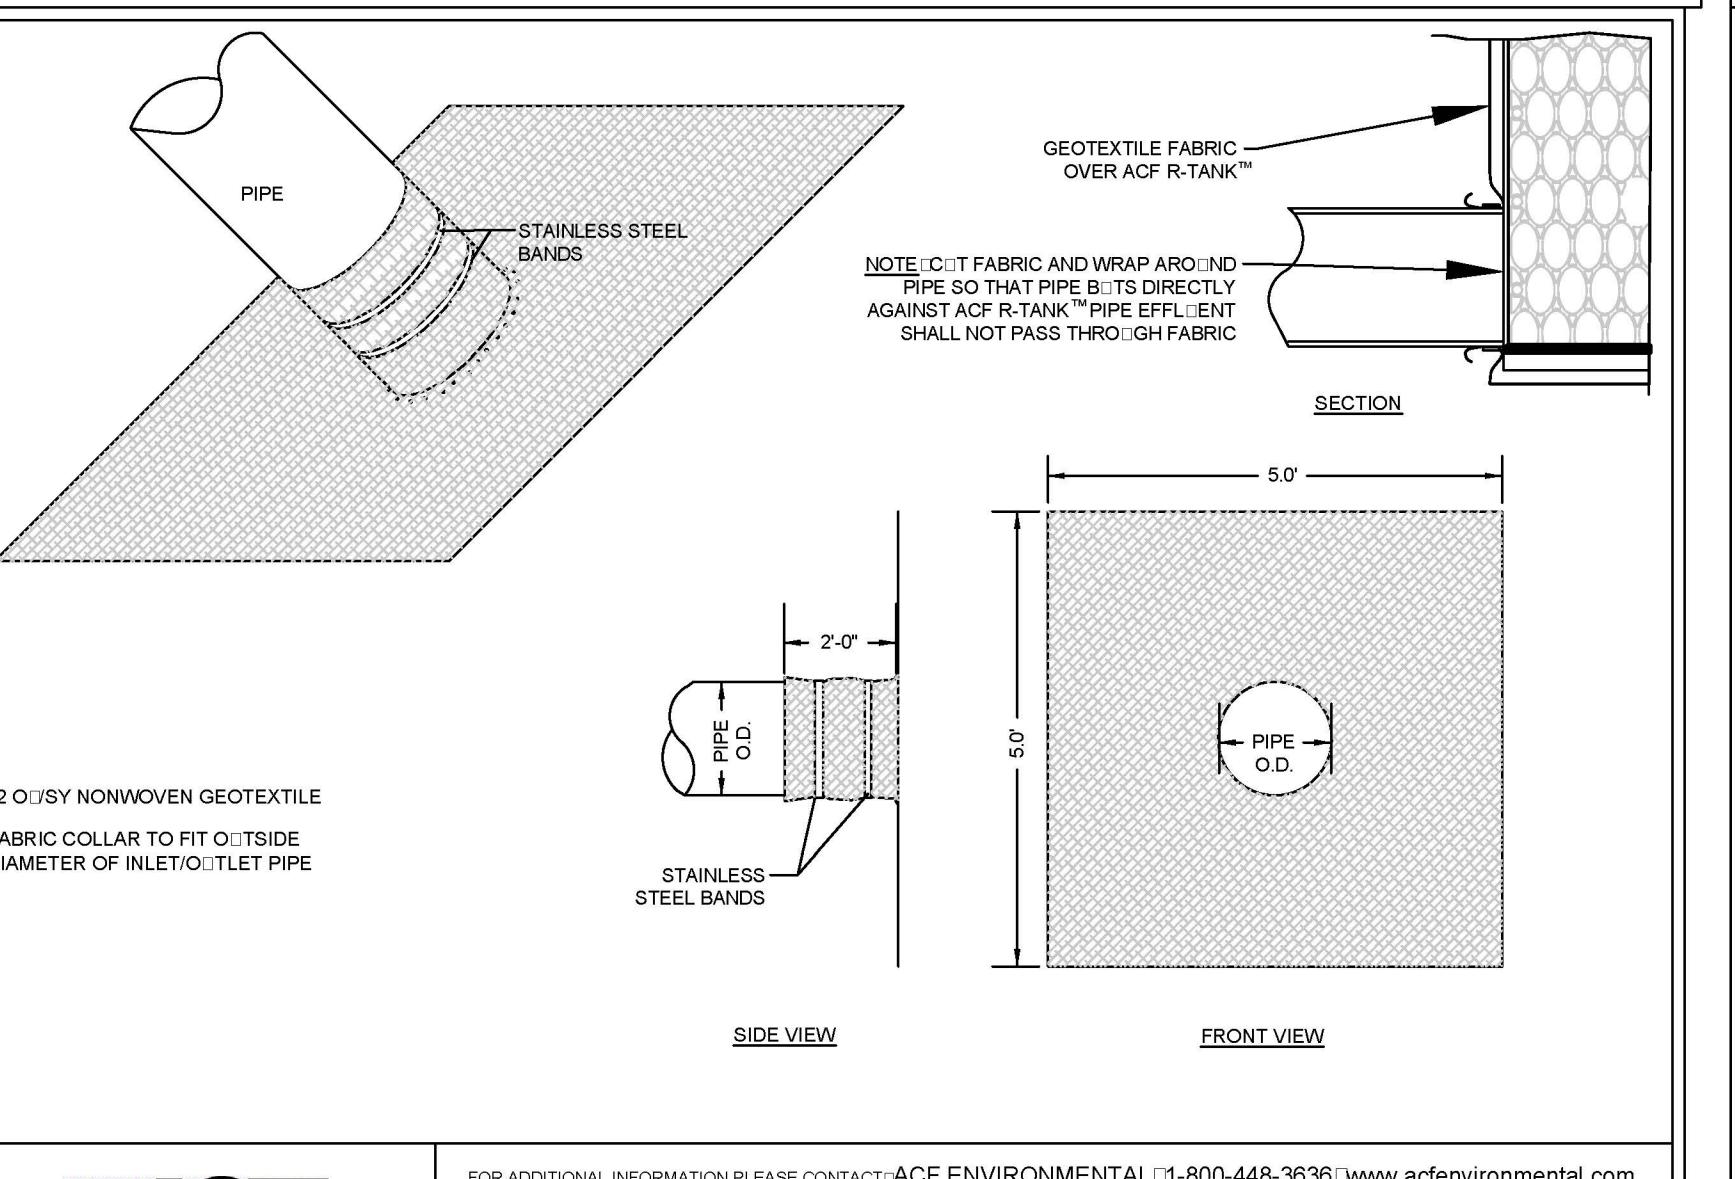


FABRIC PIPE BOOT FOR R-TANK™


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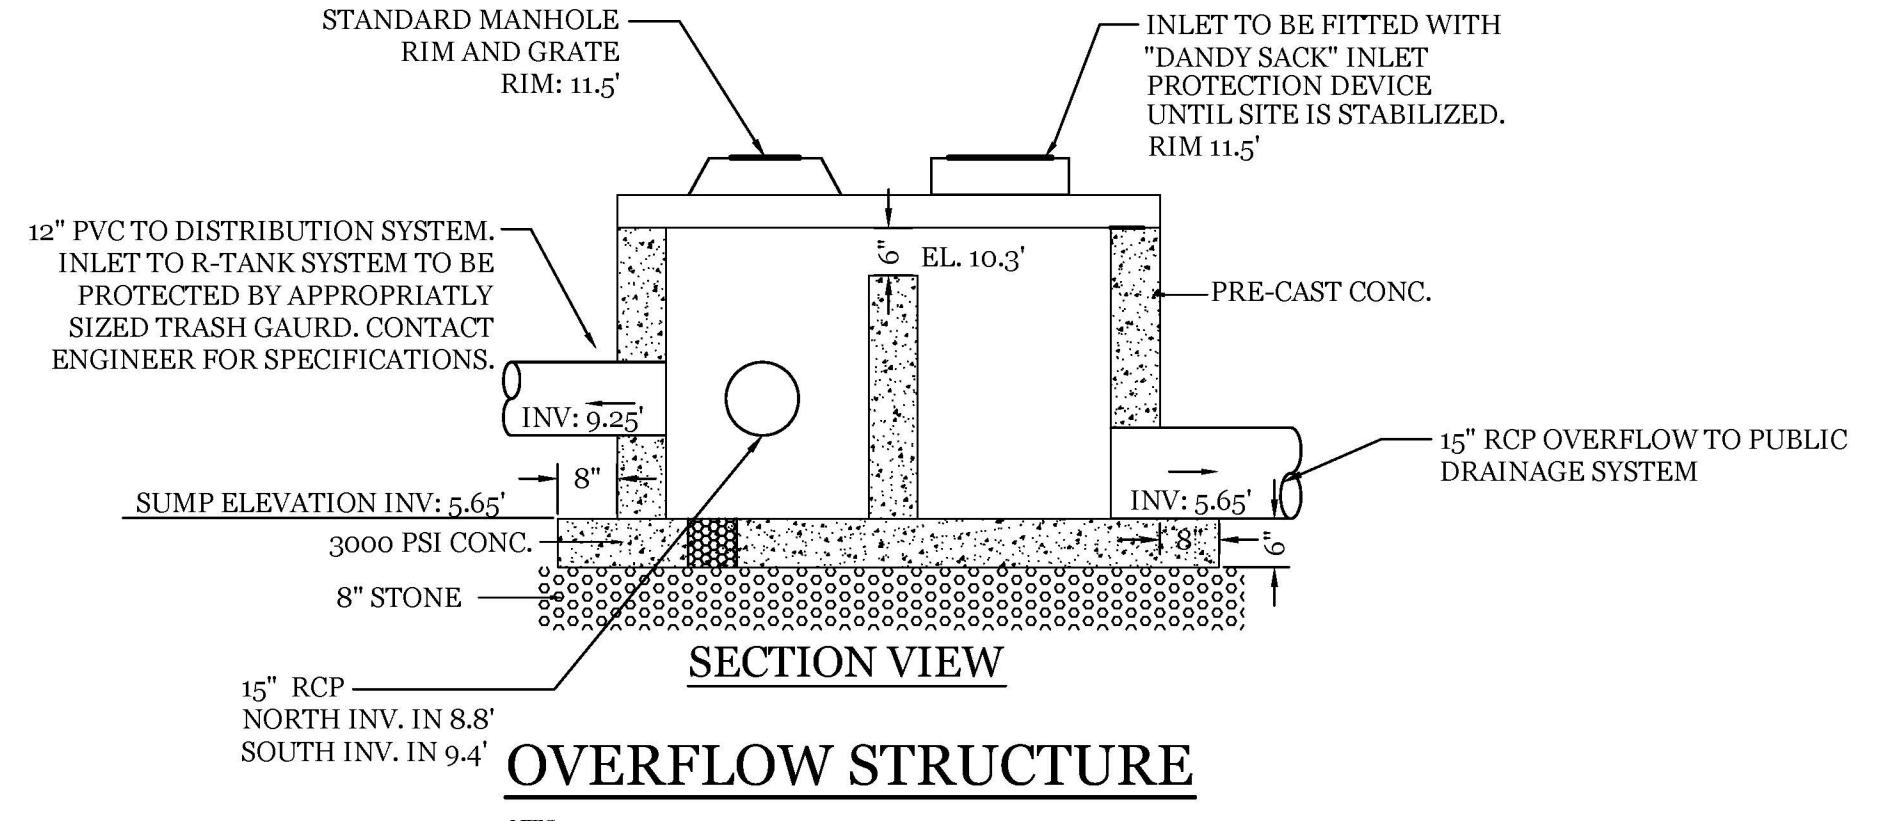
R-TANK™ TYPICAL TANK INLET/OUTLET DETAIL

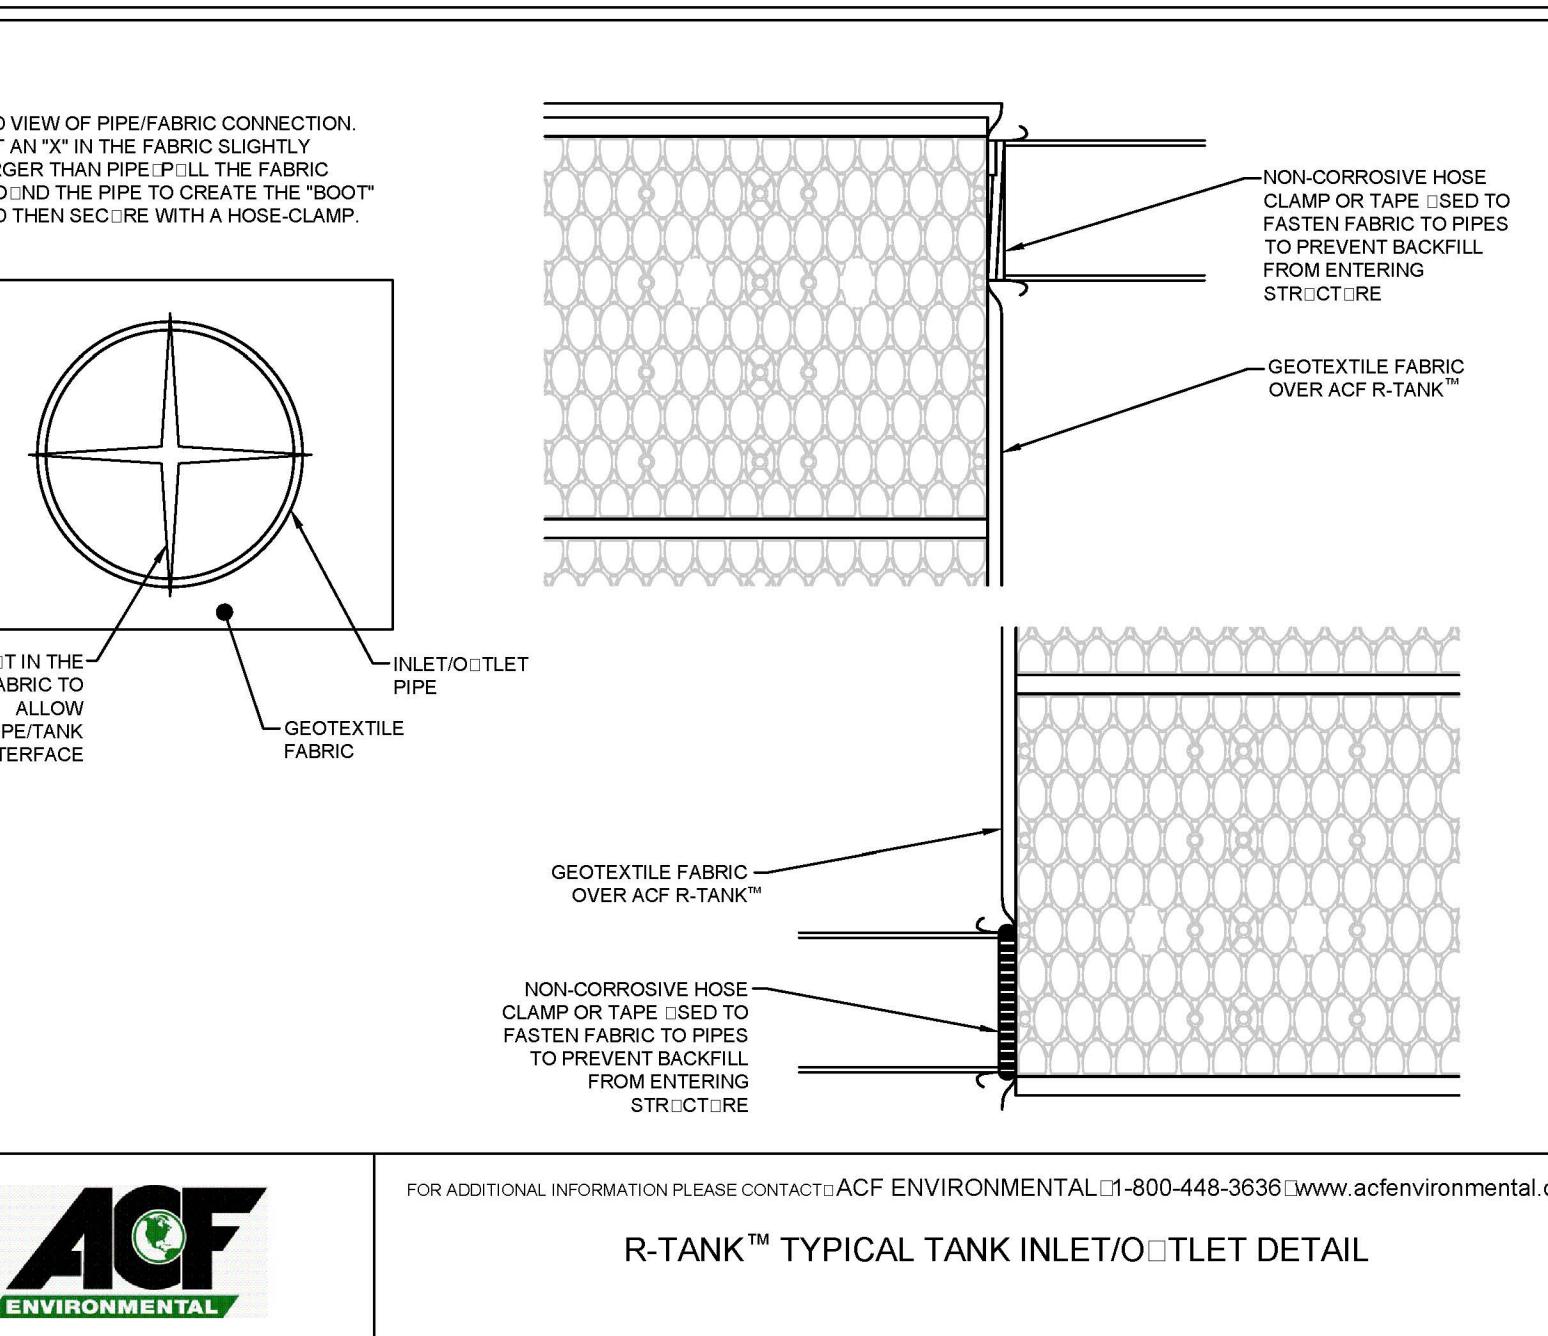


DANDY SACK DETAIL

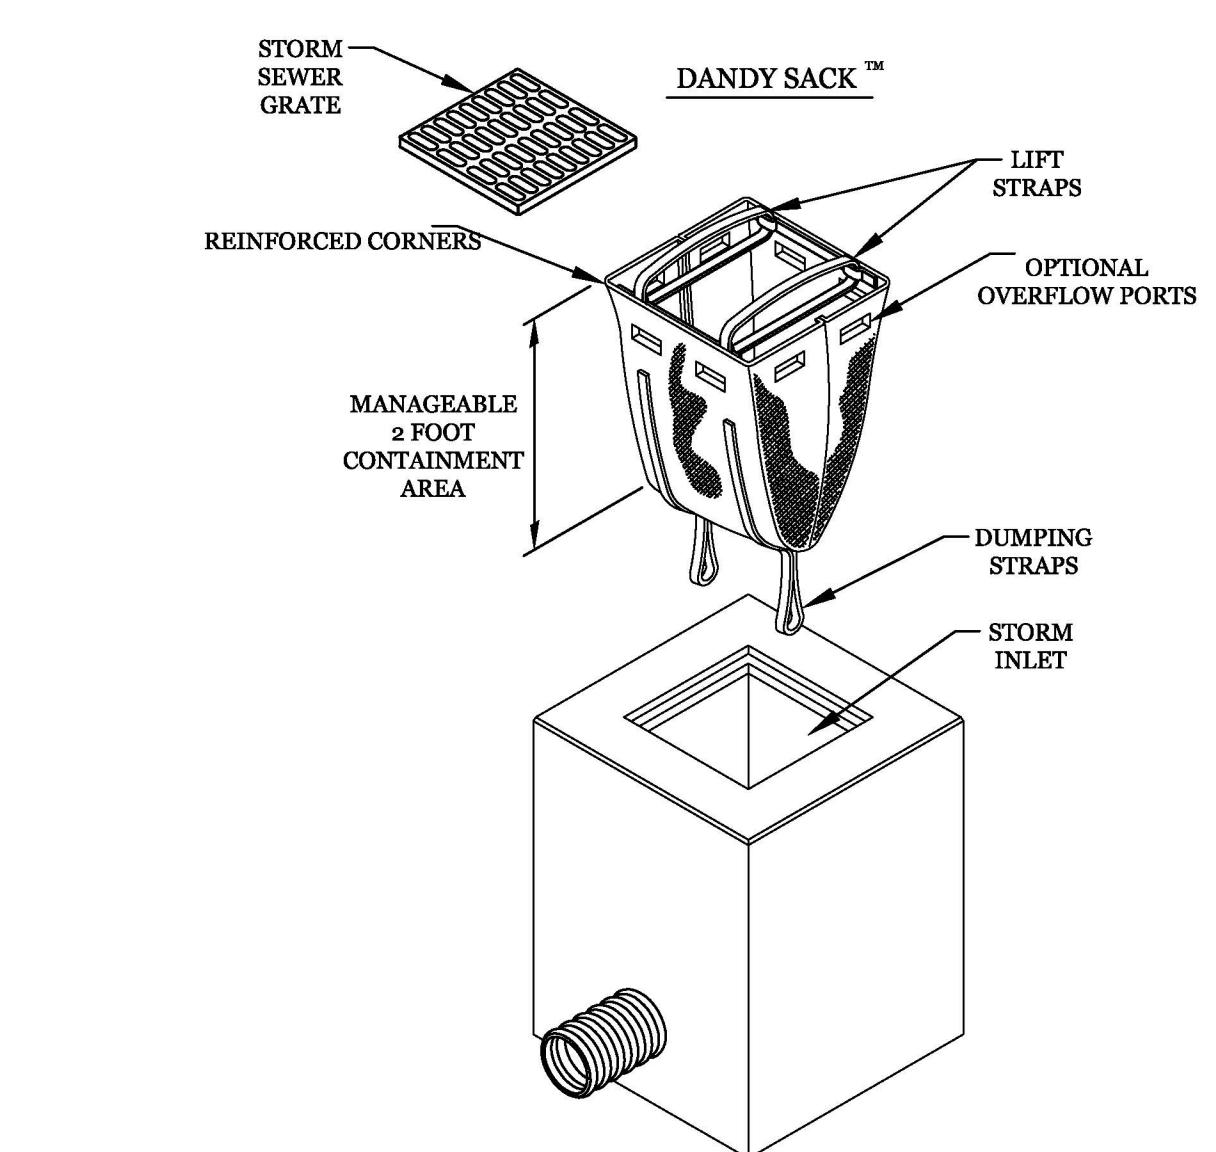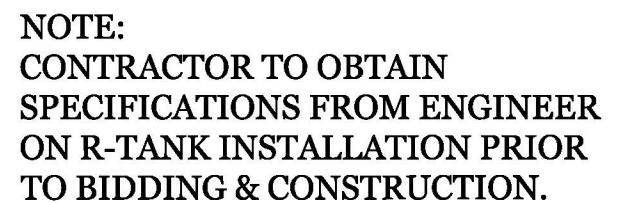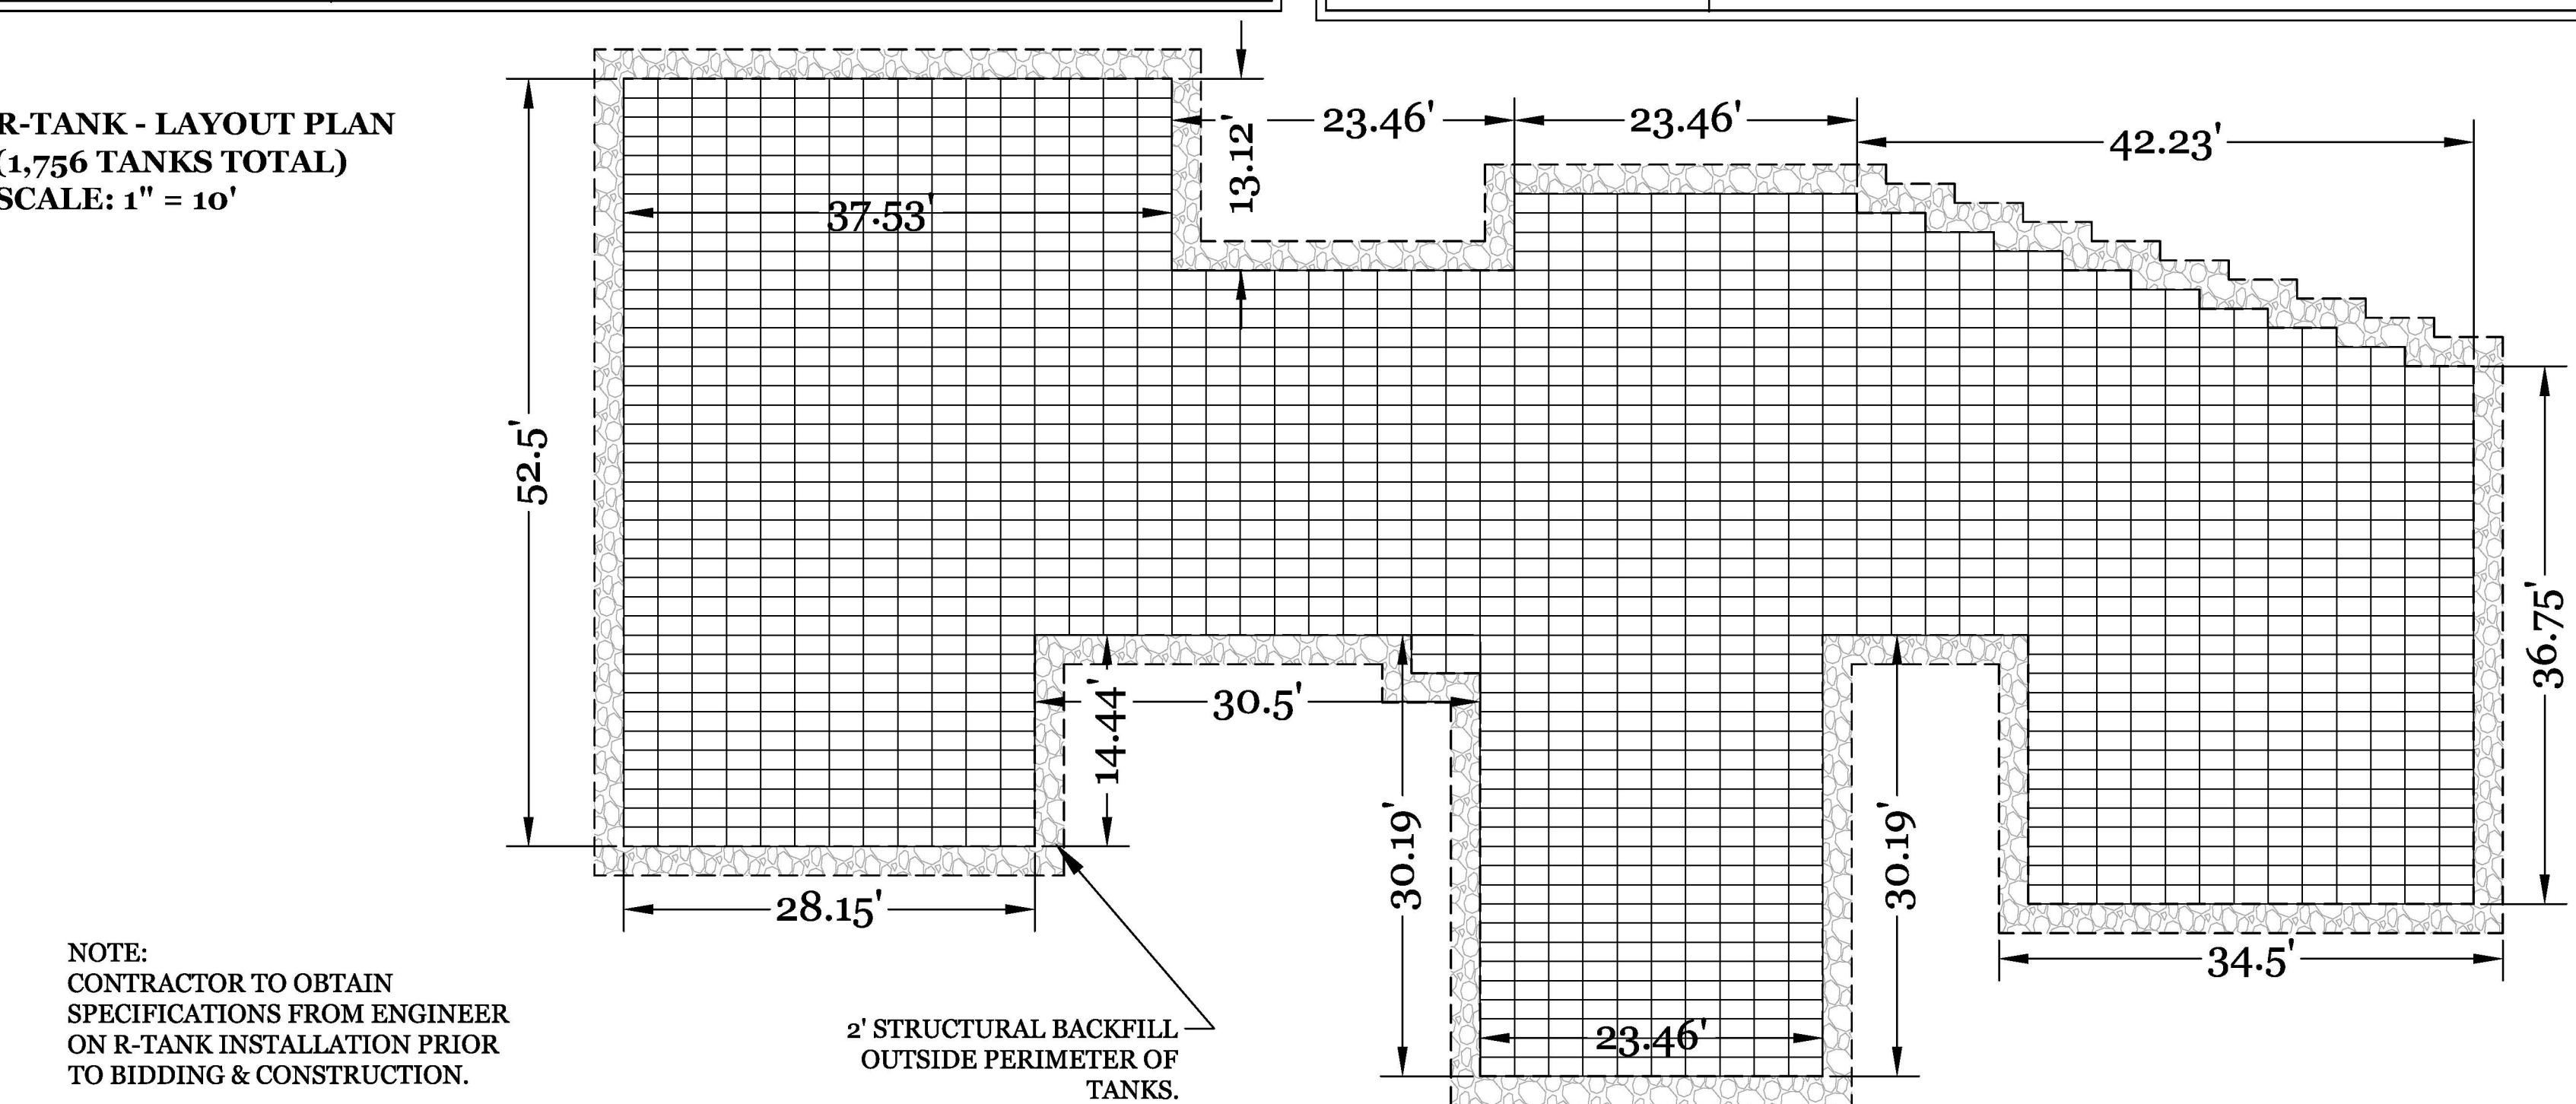


(NORTH)

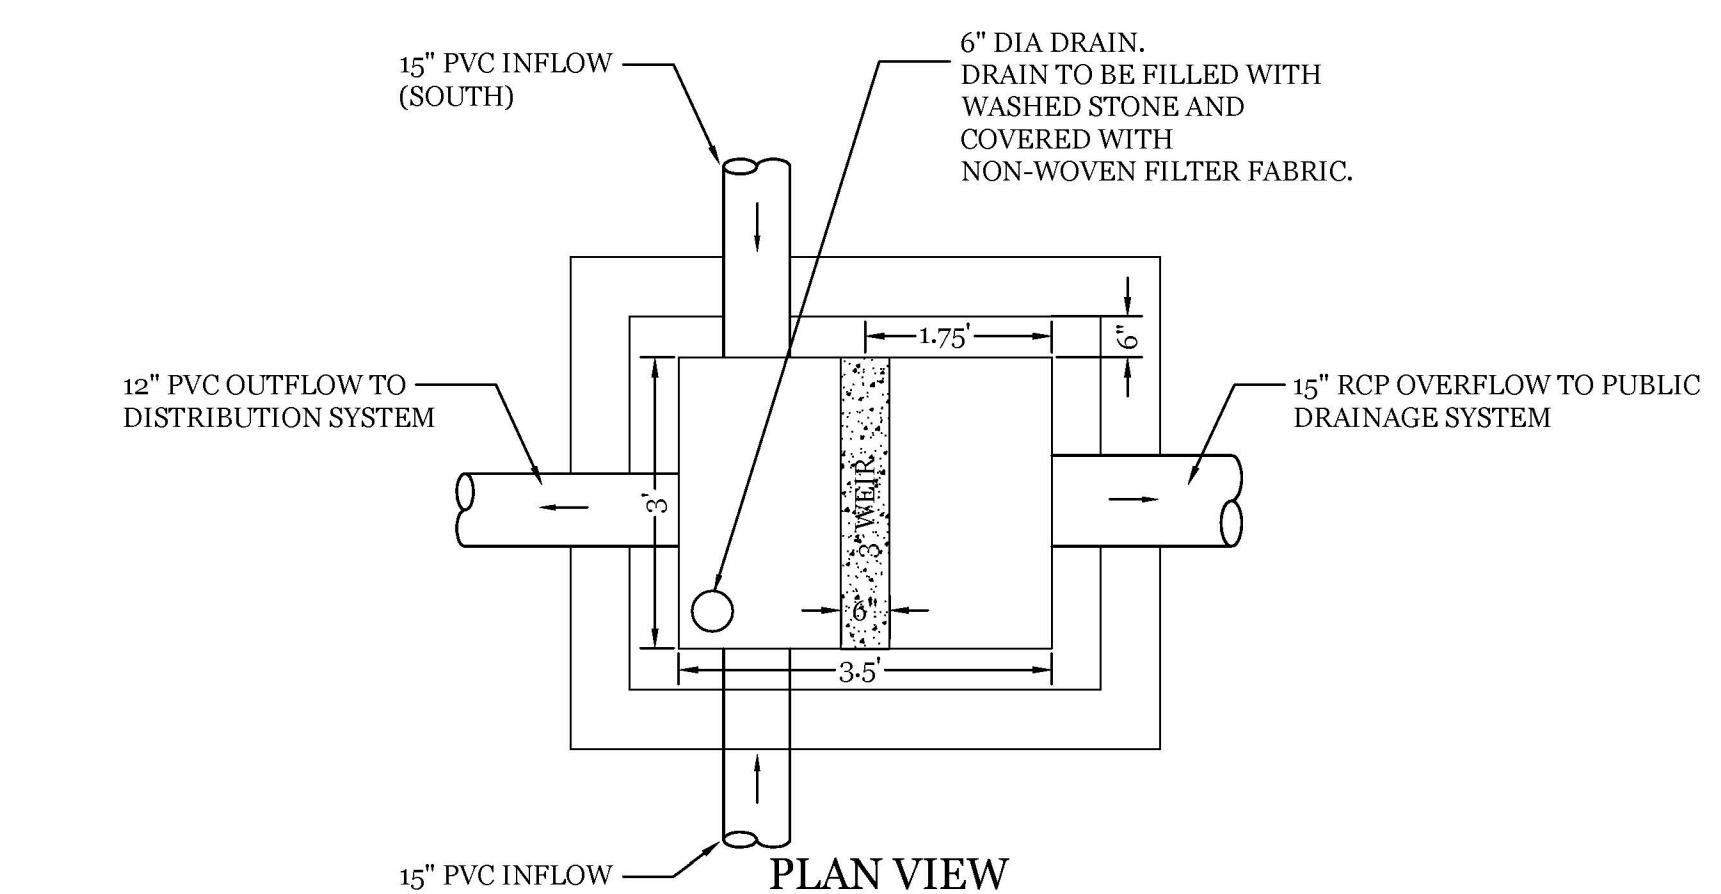

IN 8.8'

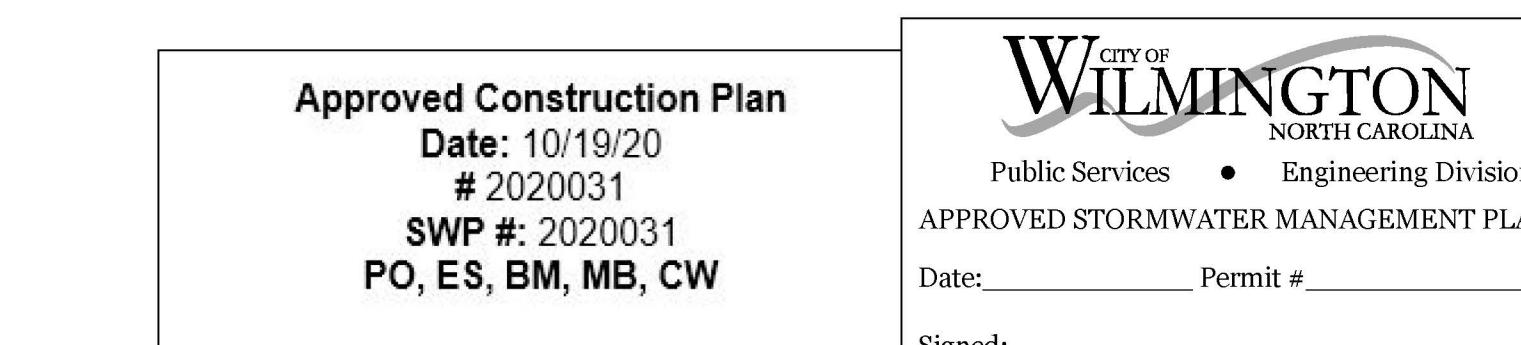


Approved Construction Plan
Date: 10/19/20
2020031
SWP #: 2020031
PO, ES, BM, MB, CW

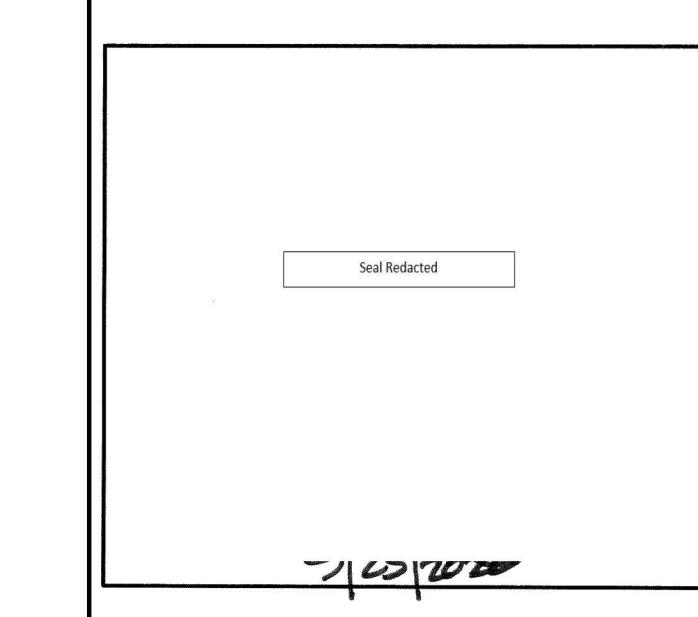

CLIENT INFORMATION:

DRAWN:	JAE	SHEET SIZE:	24x36
CHECKED:	CDC	DATE:	9/25/2020
APPROVED:	CDC	SCALE:	NTS
PROJECT NUMBER:		2019-019	

ER: C-5

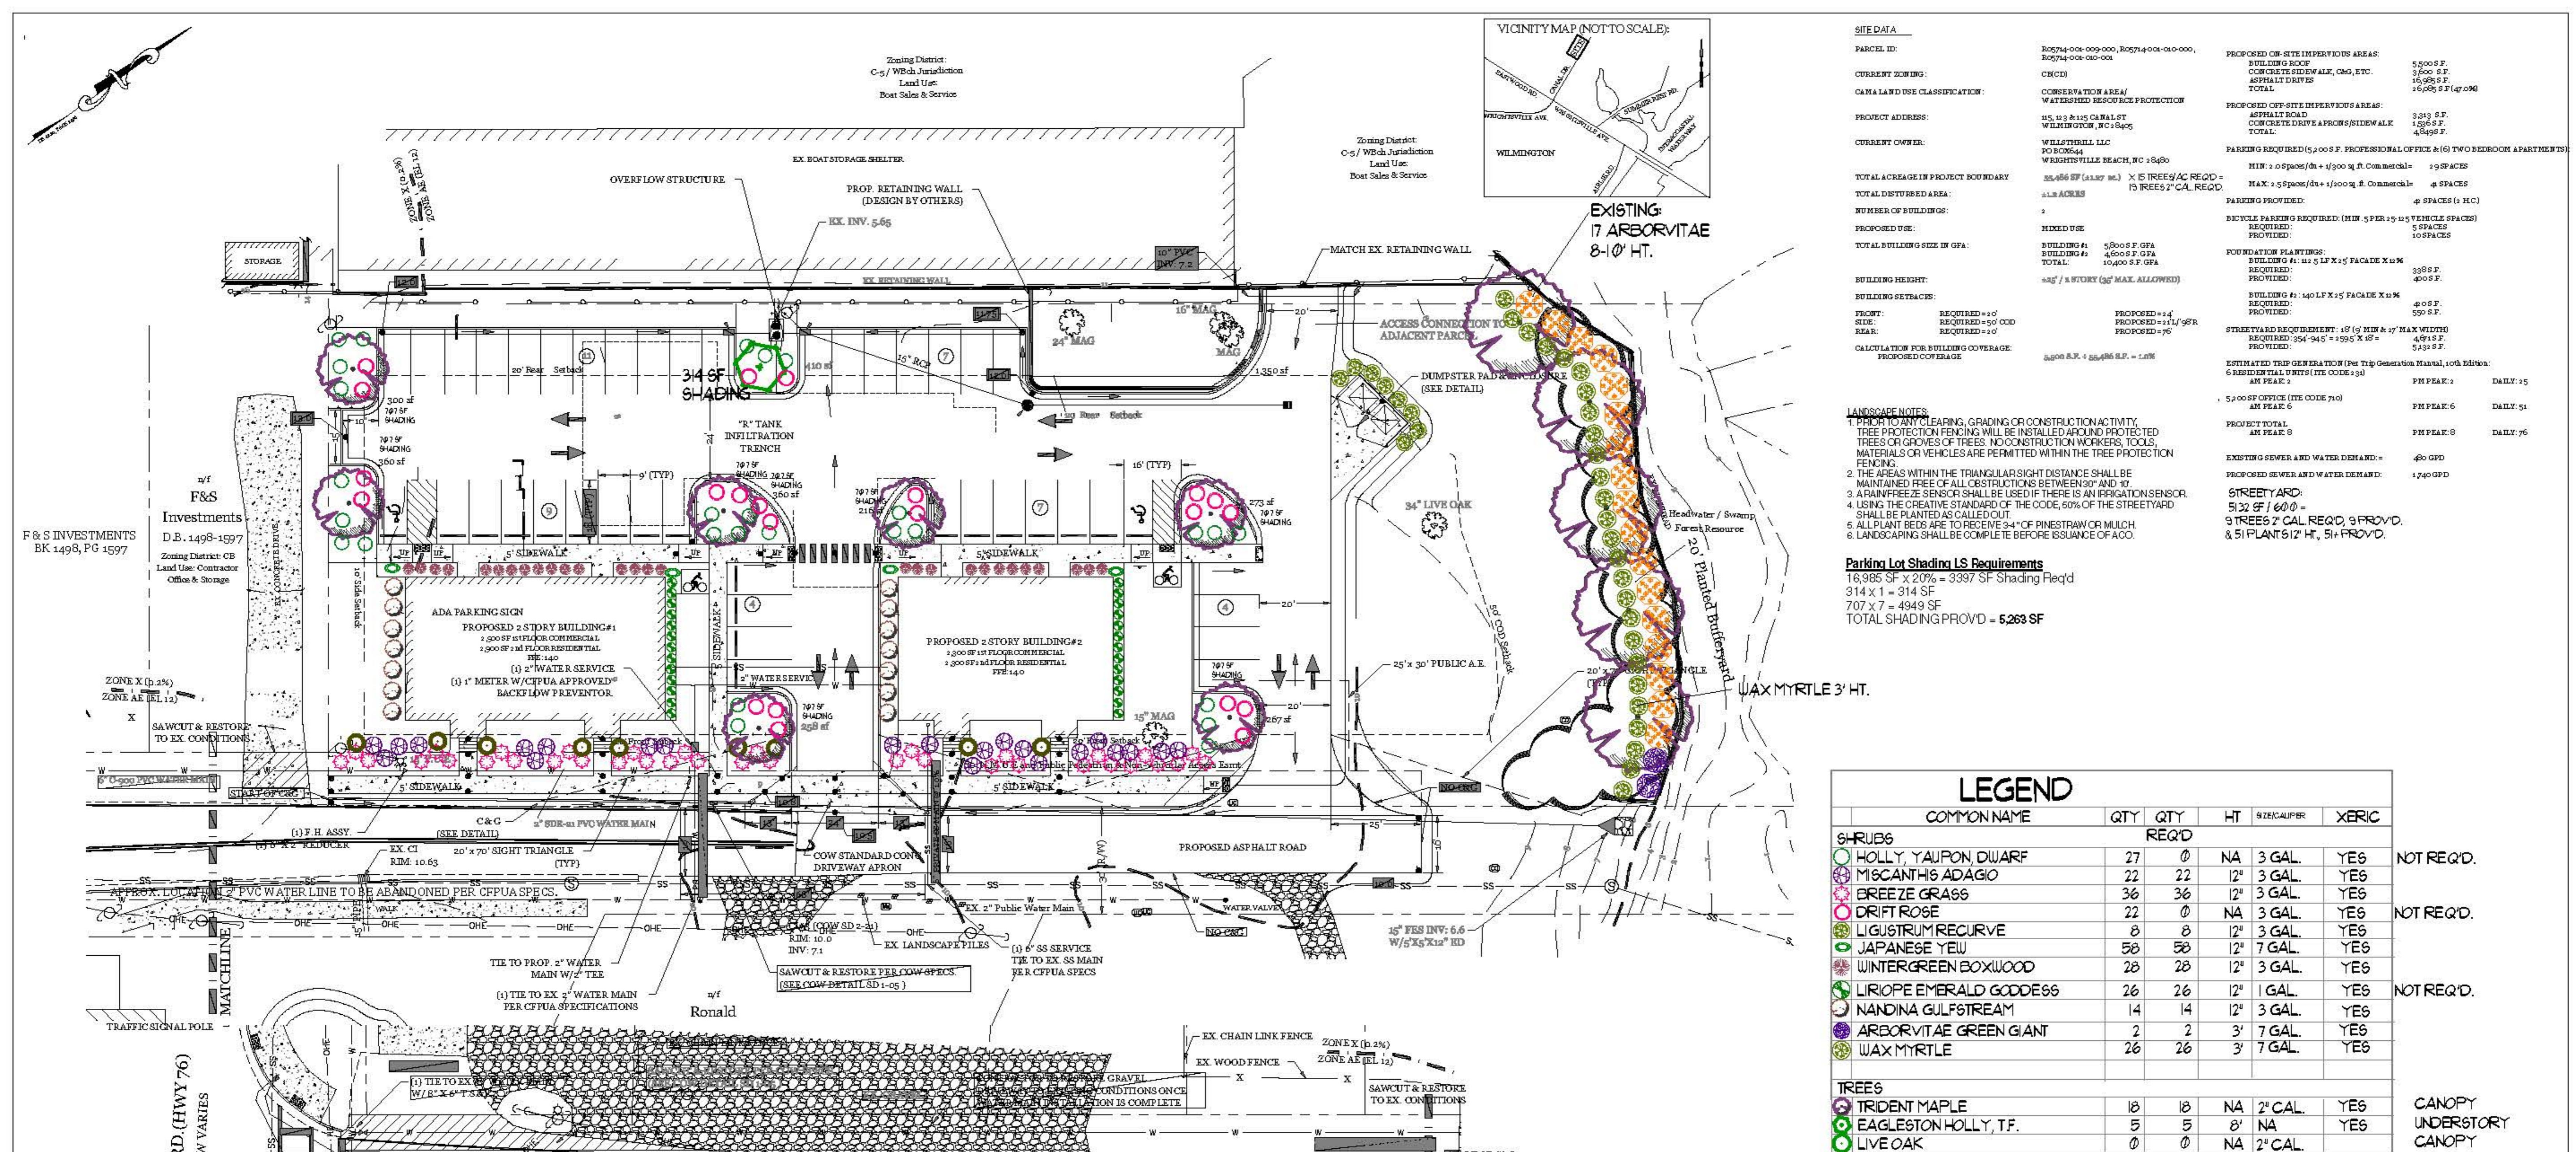

COMMON NAME	QTY	QTY	HT	SIZE/GAUFER	XERIC
REQ'D					
SHRUBS					
HOLLY, TAUPON, DWARF	27	0	NA	3 GAL.	YES
MISCANthus ADAGO	22	22	12"	3 GAL.	YES
BREEZE GRASS	36	36	12"	3 GAL.	YES
DRIFT ROSE	22	0	NA	3 GAL.	YES
LIGUSTRUM RECURVE	8	8	12"	3 GAL.	YES
JAPANESE YEW	58	58	12"	7 GAL.	YES
WINTERGREEN BOXWOOD	28	28	12"	3 GAL.	YES
LIRIOPE EMERALD GODDESS	26	26	12"	1 GAL.	YES
NANDINA GULFSTREAM	14	14	12"	3 GAL.	YES
ARBORVITAE GREEN GIANT	2	2	3'	7 GAL.	YES
WAX MYRTLE	26	26	3'	7 GAL.	YES
NOT REQ'D.					
TREES					
TRIDENT MAPLE	18	18	NA	2" CAL.	YES
EAGLESTON HOLLY, T.F.	5	5	8'	NA	YES
LIVE OAK	0	0	NA	2" CAL.	NO
REDBUD	9	9	8'	8' HT.	YES
NOT REQ'D.					
CANOPY UNDERSTORY CANOPY UNDERSTORY					

WILMINGTON
NORTH CAROLINA
Public Services • Engineering Division
APPROVED STORMWATER MANAGEMENT PLAN
Date: _____ Permit #: _____
Signed: _____

Approved Construction Plan
Date: 10/19/20
2020031
SWP #: 2020031
PO: ES, BM, MB, CW



Revision #: 1

Date: 10/12/2020

Scale:

1" = 20'



Landscape Plan:
CANAL STREET
Atlantic Marine

CANAL STREET

Landscape Design by: Jim Freeman - NCLC# 0071
Freeman Landscape, Inc.

ISOFOOTCANDLE CURVES

Fixture: 220, GALLEON
Mounting height: 30 ft
Lumens: 4,000K, 70 CRI
Pattern: Type IV, R9=0.9 (less light at above 90 degrees)
Note: The footcandle readings below are maintained and have been depreciated for LED lumen depreciation and luminaire dirt depreciation for initial footcandles.
Divide the readings below by .85.

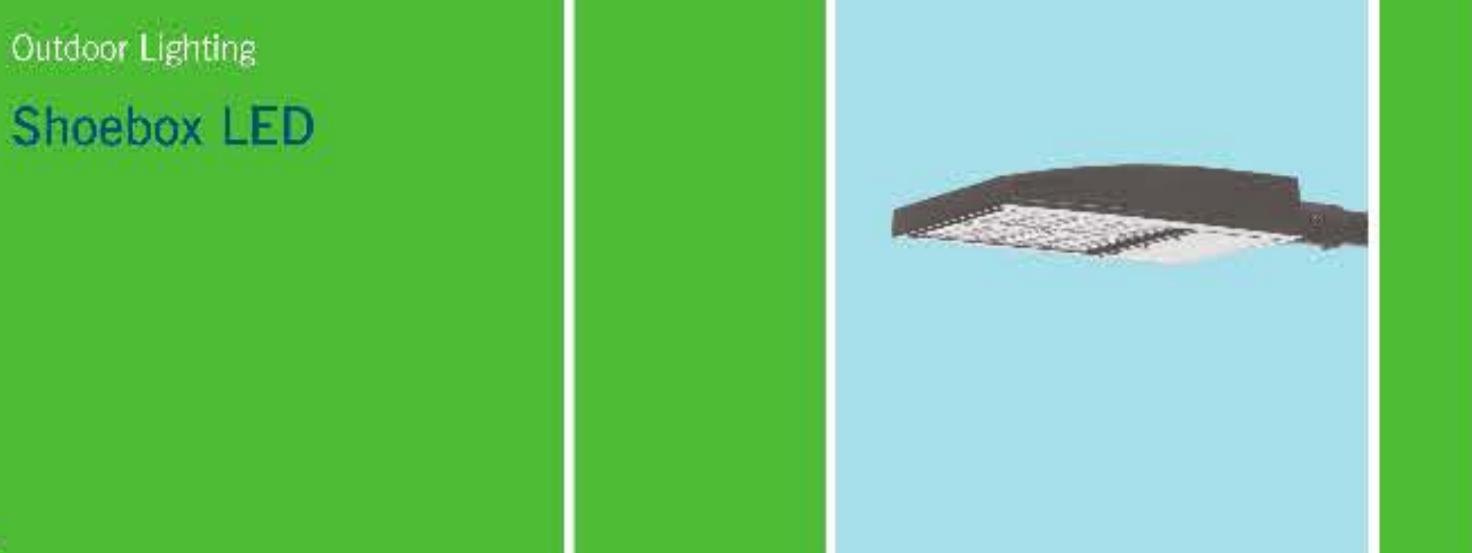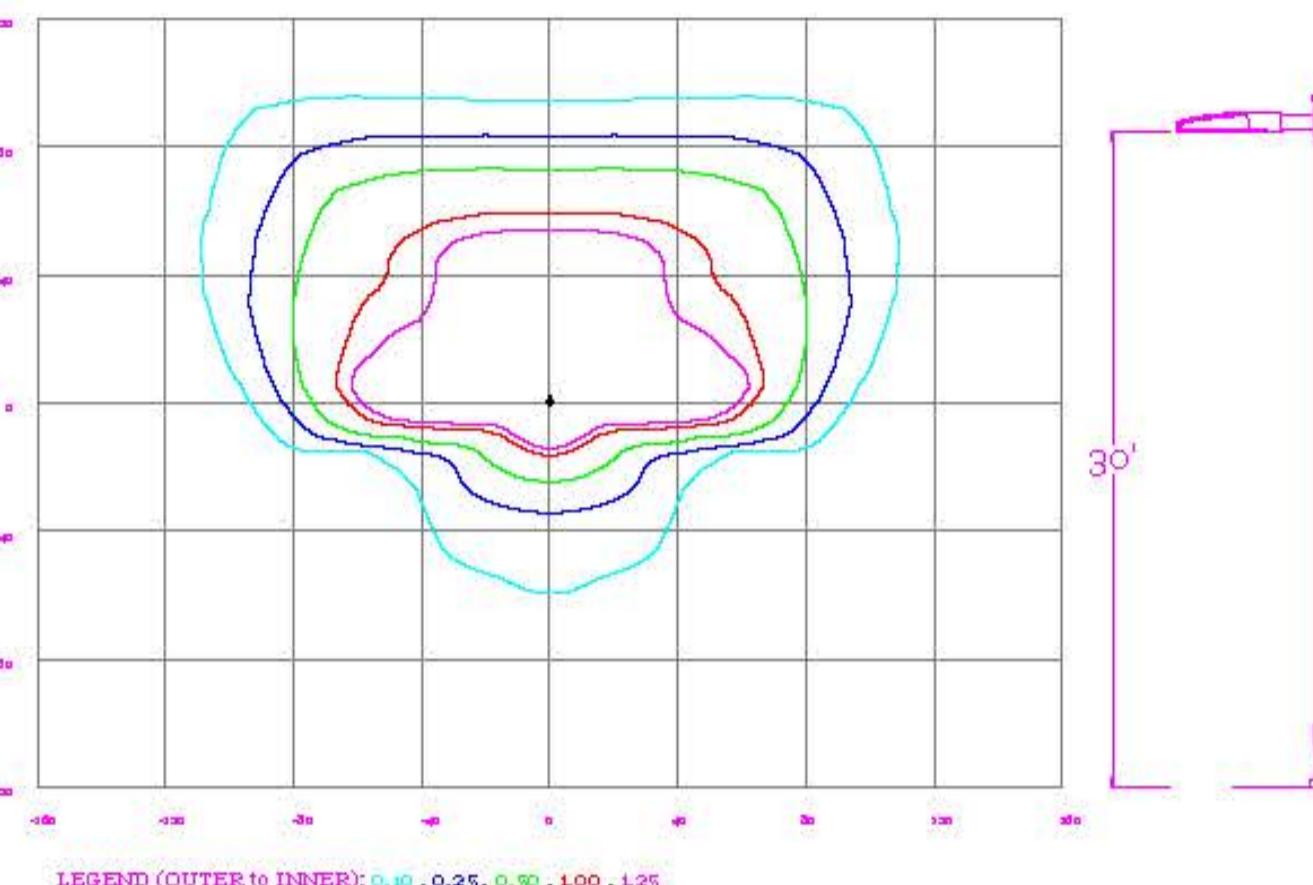

The energy-efficient Shoebox LED combines a decorative, contemporary style with versatility and ample lighting effect that is perfect for streets, parking lots, commercial buildings and residential communities. The Shoebox LED provides excellent color rendition along with a controlled light pattern that reduces glare and keeps the light directed only where you want it. Available in black, dark bronze, gray or white with one to four fixtures per pole.

LED	150, 220, 120, 530 watts (Light Emission Data)
Mounting heights	25', 30', 33'
Colors	Black Bronze Gray White
Poles	Fiberglass (1 or 2 fixtures per pole) Decorative tapered metal Decorative square metal

Note: AB code available in black or bronze only.

For additional information, visit us at duke-energy.com/OutdoorLighting or call toll free 1-866-769-6417.



Outdoor Lighting Shoebox LED

Light source: LED (white)
Replacement for: LED Wattage 150 – 250-watt HPS and metal halide;
LED Wattage 205 – up to 400-watt metal halide;
LLD Wattage 530 – 1,000-watt metal halide;

Warm-up and restrike time: Instant on (no warm-up or restrike time)



light distribution pattern

Wattage	BUC Rating	Light Pattern	Lumens	Color Temp
LED 150	B5-L0-G3	IESNA type V (Circular)	19580	
LLD 150	B3-U-0-G4	IESNA Type IV (Forward throw)	18459	
LED 150	B2-L0-G3	IESNA Type III (oval)	19036	
LED 220	B5-L0-G3	IESNA type V (Circular)	29870	
LED 220	B3-U-0-G4	IESNA type V (Forward throw)	24390	
LED 220	B2-L0-G4	IESNA Type III (oval)	2514	4,000K
LED 420	B5-L0-G3	IESNA Type V (Circular)	48514	
LED 420	B3-U-0-G3	IESNA type V (Circular)	4365	
LED 530	B8-L0-G3	IESNA Type V (Circular)	60296	
LED 530	B3-L0-G3	IESNA type IV (Forward throw)	51493	

* These are approximate replacement suggestions; actual conditions could be different.

Name	Mounting height	Color
Round tapered decorative metal*	35'	Black Bronze
Decorative square metal*	25' and 30'	Black Bronze Gray White

Poles available:	Features	Benefits
Round tapered decorative metal*	Little or no installation cost	Free up capital for other projects
Decorative square metal*	Design services by lighting professionals included	Meets industry standards and lighting ordinances
Fiberglass	Maintenance included	Eliminates high and unexpected repair bills
	Electricity included	Less expensive than metered service
	Warranty included	Worry-free
	One low monthly cost on your electric bill	Convenience and savings for you
	Turnkey operation	Provides hassle-free installation and service
	Backed by over 40 years of experience	A name you can trust today ... and tomorrow

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